

## Waikare Gorge Replacement

**Contaminated Land Preliminary Site** Investigation

Waka Kotahi NZ Transport Agency

20 September 2021

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## **Executive summary**

GHD Limited (GHD) was engaged by Waka Kotahi NZ Transport Agency (Waka Kotahi) to undertake a Preliminary Site Investigation (PSI) for the State Highway 2 (SH2) Waikare Gorge safety realignment project (the 'Project'). The Project, currently in a scoping and investigation phase, is part of a series of East Coast roading improvements aimed to make SH2 safer and less likely to suffer closures. As part of the Project, construction of an approximate 4.22-kilometre (km) section of roadway through rural village Putorino is proposed to provide a safer route of passage for road users. It is also part of a package of projects in the Tairāwhiti region that have been identified for enabling region-oriented economic growth.

During initial consultations with stakeholders and the community, two potential alignments were considered. They were named the 'Orange Alignment', and the 'White Alignment'. Waka Kotahi have indicated the White Alignment as the current preferred option; therefore, this PSI assessed potential contamination across the White Alignment (the 'Alignment') only.

The purpose of this PSI was to:

- Inform Waka Kotahi of the potential risks to human health from potential activities identified on the Ministry for the Environment (MfE) Hazardous Activities and Industries List (HAIL)<sup>1</sup> along and near the Alignment.
- Inform Waka Kotahi of any likely resource consent requirements under the:
  - Resource Management (National Environmental Standard for Assessing and Managing Contaminants in Soil to Protect Human Health) Regulations 2011 (NESCS).
  - Hawke's Bay Regional Resource Management Plan<sup>2</sup> (HBRRMP).
  - Wairoa District Plan<sup>3</sup>.
  - Hastings District Plan<sup>4</sup>.
- Present the findings and recommendations to Waka Kotahi.

GHD has considered potential risks to human health and the environment in relation to construction of the proposed Alignment through soil disturbance activities. GHD has created arbitrary risk ratings to be considered when these works take place in the presence of HAIL activities. These risk ratings and their definitions are outlined below:

- Low: Current or historic HAIL activities are situated 200 metres (m) or further from the proposed Alignment and a complete contaminant transport pathway between potentially contaminated soils and the proposed Alignment has been considered unlikely to present a significant risk to the proposed works.
- Low to medium: Current or historic HAIL activities are situated within 200 m of the proposed Alignment. Due
  to the proximity and nature of HAIL activities there is a potential that contamination may be encountered
  during the proposed works. Further investigation should be considered.
- Medium: Current or historic HAIL activities are adjacent to the proposed Alignment. Due to the proximity and nature of HAIL activities there is a potential that contamination may be encountered during the proposed works. Further investigation should be considered.
- High: Current or historic HAIL activities are occurring or have occurred within the proposed Alignment.
   Further investigation should be undertaken.

This PSI has identified two HAIL activities that have occurred near the proposed Alignment. Each HAIL activity has been assigned a risk rating of low to medium. These activities occurred distances of approximately 5 m from proposed supplementary works (the full context and scope of which is unknown to GHD) and 75 m from the main

<sup>&</sup>lt;sup>1</sup> Ministry for the Environment. 2011. *Hazardous Activities and Industries List (HAIL)*. Wellington, New Zealand: Ministry for the Environment. <sup>2</sup> Hawke's Bay Regional Council. 2006. *Hawke's Bay Regional Resource Management Plan (Includes Regional Policy Statement) – Operative 28 August 2006 (Republished in part as at 14 August 2021).* 

<sup>&</sup>lt;sup>3</sup> Wairoa District Council. 2005. Wairoa District Council "Purihia kia mau nga taonga tuku iho mahia nga mahi i roto i te Kaunihera o Te Wairoa i roto i te mana o Kahungunu ki te Wairoa" (Prepared under the provisions of the Resource Management Act 1991) – Operative June 2005 (Plan Change 1B Operative November 2016).

<sup>&</sup>lt;sup>4</sup> Hastings District Council. 2020. Hastings District Plan (partially operative from 12 March 2020).

soil disturbance works associated with the highway realignment works. Therefore, a potential exists that soil and groundwater has been contaminated in these areas. Based on the available information assessed during this PSI, it is unclear if the migration of potential contamination from this property has been sufficient to present a risk to human health or the environment in the proposed work areas of the Alignment. As discussed in Section 4.4.3, further investigation in these areas and the consultation of a hydrogeologist should be considered before undertaking proposed Project works (refer **Appendix A**) in these areas.

As HAIL activities have been identified as having likely occurred adjacent to the proposed work areas of the Project, the NESCS may apply depending on the nature of the proposed earthworks in this area. Based on the potential scale of the proposed works, the Project may not meet the permitted activity thresholds (refer Section 4) within the NESCS, HBRRMP, Wairoa District Plan, and Hastings District Plan for soil disturbance and removal / disposal. If this is the case, a resource consent would be required under the NESCS, HBRRMP, Wairoa District Plan, and Hastings District Plan for the proposed Project works.

Where a resource consent is required, a DSI could be used to inform an application under the HBRRMP, Wairoa District Plan, and Hastings District Plan. In terms of the NESCS, a DSI could also be used to inform a controlled or restricted discretionary consent application. Alternatively, a discretionary consent under the NESCS could be sought without initially completing a DSI. In all instances, a Contaminated Land Management Plan (CLMP) including unexpected contamination discovery protocol would require generation to support the consent process.

The assumptions and conclusions described above, should be reviewed once the extent and volume of earthworks required for the Project have been confirmed.

Based on the PSI undertaken and the available information relating to proposed soil disturbance works associated with the Project, GHD make the following recommendations<sup>5</sup>.

- Based on the nature of planned works (soil disturbance) and identified potential contamination issues, it is expected that the identified potential adverse effects to Project workers and surrounding human / environmental receptors could be managed through the implementation of a CLMP.
  - The purpose of a CLMP is to provide a guide for site workers to manage potential contamination issues during works. These issues include protocols for the management of potentially impacted soils and the protection of human health and the environment in the event of accidental discovery of contaminants. The CLMP would also be used in any resource consent application process.
  - Where investigations prior to planned soil disturbance works are not undertaken, the CLMP should contain provisions regarding soil sampling being conducted during the proposed works to inform soil management controls and soil reuse / disposal requirements. The CLMP could be supported by the completion of a DSI, particularly in areas where HAIL activities have been identified in proximity to proposed Project works during this PSI.
- Further investigation (soil sampling) be undertaken where works are to be conducted in proximity of HAIL activities identified during this PSI.
- A hydrogeologist be consulted with regard to potential groundwater contamination arising from these HAIL activities. A hydrogeologist would also be able to provide guidance on dewatering and groundwater disposal requirements if required.

GHD further recommends investigation be undertaken generally across the Alignment to:

- Support any applications for resource consent.
- Characterise soil conditions and any contamination not identified in this PSI to assist in the development of a Project-specific CLMP.
- Inform options for soil disposal and/or reuse.
- Identify if groundwater is likely to be encountered during the works.
- Inform construction methodology.

Undertaking further investigations generally across the Alignment would assist in streamlining construction activities; providing clarity on management methods (e.g. soil disposal location) prior to the commencement of excavation.

<sup>&</sup>lt;sup>5</sup> These recommendations should be reviewed once the extent and volume of earthworks required for the Project have been confirmed.

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### 1. Introduction

## 1.1 Project background

GHD Limited (GHD) has been engaged by Waka Kotahi NZ Transport Agency (Waka Kotahi) to undertake a Preliminary Site Investigation (PSI) for the State Highway 2 (SH2) Waikare Gorge safety realignment project (the 'Project'). The Project, currently in a scoping and investigation phase, is part of a series of East Coast roading improvements aimed to make SH2 safer and less likely to suffer closures. As part of the Project, construction of an approximate 4.22-kilometre (km) section of roadway through rural village Putorino is proposed to provide a safer route of passage for road users. It is also part of a package of projects in the Tairāwhiti region that have been identified for enabling region-oriented economic growth.

During initial consultations with stakeholders and the community, two potential alignments were considered. They were named the 'Orange Alignment', and the 'White Alignment'. Waka Kotahi have indicated the White Alignment as the current preferred option; therefore, this PSI shall assess potential contamination across the White Alignment (the 'Alignment') only. Concept design drawings for the Alignment are provided in **Appendix A**.

As part of the Project, the Alignment will be constructed over multiple rural properties and fall under the jurisdiction of Hawke's Bay Regional Council (HBRC) and two district councils, namely, Wairoa District Council (WDC) and Hastings District Council (HDC). The jurisdictions of WDC and HDC are separated by the Waikari River, which intersects with the Alignment at approximately the halfway point. In terms of the Alignment, WDC jurisdiction is situated north of the Waikari River, and HDC south.

## 1.2 Purpose of this PSI

The purpose of this PSI is to:

- Inform Waka Kotahi of the potential risks to human health from potential activities identified on the Ministry for the Environment (MfE) Hazardous Activities and Industries List (HAIL)<sup>6</sup> along and near the Alignment.
- Inform Waka Kotahi of any likely resource consent requirements associated with soil disturbance and disposal works during the Project, under the:
  - Resource Management (National Environmental Standard for Assessing and Managing Contaminants in Soil to Protect Human Health) Regulations 2011 (NESCS).
  - Hawke's Bay Regional Resource Management Plan<sup>7</sup> (HBRRMP).
  - Wairoa District Plan<sup>8</sup>.
  - Hastings District Plan<sup>9</sup>.
- Present the findings and recommendations of the assessment to Waka Kotahi.

#### 1.2.1 Objectives of this PSI

Drawn from the purpose (refer Section 1.2), the objectives of this PSI are to:

- Compile readily available current and historic information.
- Identify potential HAIL sites along and near the Alignment.
- Assess the likelihood of contamination present along the Alignment and its vicinity associated with the identified HAIL sites (if any).
- Provide Waka Kotahi with information necessary to support any future consenting requirements relating to the NESCS, HBRRMP, Wairoa District Plan, and Hastings District Plan.

<sup>&</sup>lt;sup>6</sup> Ministry for the Environment. 2011. *Hazardous Activities and Industries List (HAIL)*. Wellington, New Zealand: Ministry for the Environment. 
<sup>7</sup> Hawke's Bay Regional Council. 2006. *Hawke's Bay Regional Resource Management Plan (Includes Regional Policy Statement) – Operative* 28 August 2006 (Republished in part as at 14 August 2021).

<sup>&</sup>lt;sup>8</sup> Wairoa District Council. 2005. Wairoa District Council "Purihia kia mau nga taonga tuku iho mahia nga mahi i roto i te Kaunihera o Te Wairoa i roto i te mana o Kahungunu ki te Wairoa" (Prepared under the provisions of the Resource Management Act 1991) – Operative June 2005 (Plan Change 1B Operative November 2016).

<sup>9</sup> Hastings District Council. 2020. Hastings District Plan (partially operative from 12 March 2020).

#### 1.3 Scope of works

In order to achieve the objectives of this PSI (refer Section 1.2.1), the following scope of works were undertaken:

- A review of the existing land use and environment surrounding the Alignment.
- A review of the geology, topography, hydrology, and hydrogeology along the Alignment.
- A review of readily available historical aerial imagery to identify historical land uses and potential HAIL sites.
- A review of information provided by HBRC, WDC, and HDC (if any).
- Assessment of the primary contaminants of concern.
- Identification of potential pathways and sensitive receptors.
- Assessment of the risks to human health and the environment.
- Preparation of this report for Waka Kotahi presenting the findings and recommendations.

#### 1.3.1 Methodology

This PSI has been prepared in general accordance with current editions of the following national documents:

- NESCS: Resource Management (National Environmental Standard for Assessing and Managing Contaminants in Soil to Protect Human Health) Regulations 2011.
- NESCS Users' Guide: Ministry for the Environment. 2012. Users' Guide: National Environmental Standard for Assessing and Managing Contaminants in Soil to Protect Human Health. Wellington: Ministry for the Environment.
- CLMG No 1: Ministry for the Environment. 2021. Contaminated land management guidelines No 1: Reporting on contaminated sites in New Zealand (Revised 2021). Wellington: Ministry for the Environment.
- CLMG No 5: Ministry for the Environment. 2021. Contaminated land management guidelines No 5: Site investigation and analysis of soils (Revised 2021). Wellington: Ministry for the Environment.

#### 1.3.1.1 Suitably Qualified and Experienced Practitioner

Adam Gray, a reviewer and signatory of this PSI, meets the guidelines of a Suitably Qualified and Experienced Practitioner (SQEP) as outlined in the NESCS Users' Guide. The NESCS Users' Guide provides an interpretive description of the NESCS as to the expertise of a SQEP.

Adam is a technical director for the contamination assessment and remediation service line at GHD in New Zealand. Adam has over 15 years' experience in the assessment, remediation, and management of contaminated land in both New Zealand and Australia. Adam's full curriculum vitae (CV) is available upon request.

#### 1.4 Limitations

This report has been prepared by GHD for Waka Kotahi NZ Transport Agency and may only be used and relied on by Waka Kotahi NZ Transport Agency for the purpose agreed between GHD and Waka Kotahi NZ Transport Agency as set out in Section 1.2 of this report.

GHD otherwise disclaims responsibility to any person other than Waka Kotahi NZ Transport Agency arising in connection with this report. GHD also excludes implied warranties and conditions, to the extent legally permissible.

The services undertaken by GHD in connection with preparing this report were limited to those specifically detailed in the report and are subject to the scope limitations set out in the report.

The opinions, conclusions and any recommendations in this report are based on conditions encountered and information reviewed at the date of preparation of the report. GHD has no responsibility or obligation to update this report to account for events or changes occurring subsequent to the date that the report was prepared.

The opinions, conclusions and any recommendations in this report are based on assumptions made by GHD described in this report (refer Section 1.5 of this report). GHD disclaims liability arising from any of the assumptions being incorrect.

GHD has prepared this report on the basis of information provided by Waka Kotahi NZ Transport Agency and others who provided information to GHD (including Government authorities), which GHD has not independently verified or checked beyond the agreed scope of work. GHD does not accept liability in connection with such unverified information, including errors and omissions in the report which were caused by errors or omissions in that information.

The opinions, conclusions, and any recommendations in this report are based on information obtained from, and testing undertaken at or in connection with, specific sample points. Site conditions at other parts of the site may be different from the site conditions found at the specific sample points.

Investigations undertaken in respect of this report are constrained by the particular site conditions, such as the location of buildings, services, and vegetation. As a result, not all relevant site features and conditions may have been identified in this report.

Site conditions (including the presence of hazardous substances and/or site contamination) may change after the date of this report. GHD does not accept responsibility arising from, or in connection with, any change to the site conditions. GHD is also not responsible for updating this report if the site conditions change.

#### 1.5 Assumptions

The PSI methodology was developed with consideration given to the following assumptions:

- Information obtained from Waka Kotahi and third parties (including governing bodies) is complete and accurate.
- The observations made during the PSI are representative of the activities that have occurred or are occurring along or near the Alignment.
- The observed and inferred site conditions are representative of the actual site conditions and those not directly assessed.
- This report is based on the Alignment at the time of writing. If the proposed alignment route changes, then reassessment should be undertaken.
- At the time of writing, the construction methodologies including proposed soil disturbance and disposal
  volumes are yet to be confirmed. A review of this report and likely resource consent requirements should be
  undertaken once the extent and volume of earthworks required for the Project has been confirmed.

#### 1.6 Third party reliance

This report is the property of GHD, unauthorised use is prohibited. It is intended for the use of Waka Kotahi only. It has been prepared in accordance with the Terms of Engagement for this commission and based on specific instructions and information provided by Waka Kotahi for exclusive use by Waka Kotahi for its particular purpose.

The contents and conclusions of this report may therefore be inappropriate for any other party in the context of that party's particular purposes and circumstances. Any other party should obtain its own independent information or advice and no responsibility is accepted nor duty of care assumed by GHD to any other party who may use or rely on all or any part of the content of this report.

## 2. Statutory context

#### 2.1 National regulations

#### 2.1.1 **NESCS**

The NESCS is a nationally consistent set of planning controls and soil contaminant values. The NESCS regulates certain activities on contaminated land and provides human health risk-based standards for management of these activities; however, the NESCS does not include criteria for environmental risk assessment.

The NESCS applies to 'pieces of land' on which any HAIL activity is 'more likely than not' to have occurred. Furthermore, it applies to soil disturbance activities where the following permitted activity thresholds are exceeded:

- Soil disturbance greater than 25 metres cubed (m³) per 500 metres squared (m²) on the piece of land associated with the HAIL.
- Soil removal greater than 5 m<sup>3</sup> per 25 m<sup>2</sup> for the piece of land associated with the HAIL.

These permitted activity thresholds including other triggers are detailed in Regulation 8(3) of the NESCS. The NESCS also regulates the following:

- Site investigation and reporting.
- Soil sampling for contamination assessment.
- Removal of underground fuel storage systems.
- Contamination investigations and health risk assessments when subdividing land and/or changing land use.

#### 2.1.1.1 Applicability

If a HAIL activity is identified as having more likely than not occurred, the NESCS is considered applicable. If the scale of soil disturbance and/or removal exceeds the permitted activity thresholds detailed above, the requirement for resource consent under the NESCS is triggered.

The volume of soil disturbance and/or removal during Project construction (while currently unknown) is anticipated above the permitted activity criteria under Regulation 8(3) of the NESCS. If these thresholds amongst others are not met, then resource consent will be required. A resource consent application should include a Detailed Site Investigation (DSI) to assess whether the construction works fall under a controlled or restricted discretionary activity consent. However, the NESCS would no longer apply if the DSI demonstrates that the contaminants of concern in, or on, the piece of land where the Alignment is proposed are at or below background concentrations. The applicability of the NESCS based on the PSI findings is further discussed in Section 5.2 of this report.

Under the NESCS, a DSI is considered a permitted activity; therefore, a DSI does not trigger the requirements for resource consent.

### 2.2 Regional and district-based regulations

Councils are required to manage both the use of land containing elevated levels of contaminants and the discharge of contaminants from land containing elevated levels of contaminants. Therefore, councils may impose controls in addition to the NESCS for environmental protection.

#### 2.2.1 HBRRMP

The HBRRMP includes the following policy associated with contaminated land, detailed in Section 5.2.1: Table 5. Environmental Guidelines – Land (5. Soil contamination):

 The discharge of contaminants into the soil, including hazardous substances, pathogens and diseases, should be at a level that will not cause acute or chronic toxic effects on humans or other non-target species, or have the potential to reduce long-term land use potential. The following rule associated with soil disturbance is detailed in Section 6.3.3 Vegetation Clearance and Soil Disturbance Activities:

#### Rule 7: Vegetation clearance and soil disturbance

- Permitted:
- a. All cleared vegetation, disturbed soil or debris shall be deposited or contained to reasonably prevent the transportation or deposition of disturbed matter into any water body.
- b. Vegetation clearance or soil disturbance shall not give rise to any significant change in the colour or clarity of any adjacent water body, after reasonable mixing.
- c. No vegetation clearance shall occur within 5 metres of any permanently flowing river, or any other river with a bed width in excess of 2 metres, or any other lake or wetland, except that this condition shall not apply to:
  - i. the clearance of plantation forestry established prior to the date of this Plan becoming operative; or 10
  - ii. the areas identified in Schedule X to this Plan.
- d. Deposition of soil or soil particles across a property boundary shall not be objectionable or offensive, cause property damage or exceed  $10 \text{ kg/m}^2$ .
- e. Where the clearance of vegetation or the disturbance of soil increases the risk of soil loss the land shall be:
  - re-vegetated as soon as practicable after completion of the activity, but in any event no later than 18 months with species providing equivalent or better land stabilisation; or
  - ii. retained in a manner which inhibits soil loss.
- Restricted discretionary (Matters for Discretion):
- a. The conditions, standards or terms which the activity cannot comply with, and the related environmental effects.
- b. Monitoring and reporting requirements.
- c. Duration of consent.
- d. Review of consent conditions.

#### 2.2.2 Wairoa District Plan

As discussed in Section 1.1, the Alignment falls under WDC jurisdiction on the northern side of the Waikari River. Under the Wairoa District Plan, this land is situated in the 'Rural Zone'.

The Wairoa District Plan outlines criteria for permitted and discretionary activities in the Rural Zone. Any activity unable to comply with the standards and conditions for permitted activities are considered discretionary and require resource consent.

Permitted activity standards pertaining to soil disturbance are detailed in Section 6.8.18: Earthworks:

- Earthworks activities shall meet the following standards:
  - Maximum volume over 12 months per site of 250 m<sup>3</sup>.
  - Maximum face height of 1.5 metres (m).
  - Maximum area of work per site of 400 m<sup>2</sup>.
  - Proximity to water body measured from the bank edge at bank full height no closer than 20 m.

#### 2.2.3 Hastings District Plan

As discussed in Section 1.1, the Alignment falls under HDC jurisdiction on the southern side of the Waikari River. Under the Hastings District Plan, this land is situated in the 'Rural Zone'. The Hastings District Plan outlines criteria pertaining to earthworks in Section 27.1: Earthworks, Mineral, Aggregate and Hydrocarbon Extraction:

Rule EM3: The removal offsite of less than 25 m³ of topsoil, sand, gravel, metal and earth in the Plains
 Production Zone and less than 100 m³ of topsoil, sand, gravel, metal and earth per site per year from sites in all other zones is classified as a Permitted Activity.

<sup>&</sup>lt;sup>10</sup> Strikethrough copied as per the HBRRMP.

- Rule EM10: The removal offsite of more than 100 m³ of earth (including topsoil) per site per year from sites in any Zone (excluding Plans Production Zone) is classified as a Discretionary Activity.
- The total volume of earthworks<sup>11</sup> allowed as a Permitted Activity in the Rural Zone is 2000 m<sup>3</sup> per hectare (ha) of site.
- Where vegetation clearance occurs (except where it is associated with the operation, maintenance or upgrading of lawfully established roads, tracks, and drainage channels), disturbed areas shall be re-pastured or revegetated as soon as practicable within 18 months of the activity ceasing.
- Earthworks shall not be undertaken on land with a slope of greater than 45° degrees above horizontal.
- No earthworks shall have a cut/fill face of overall vertical extent greater than 5 metres in the Rural Zone.
- No excavations shall be greater than 1 metre vertical extent of cut/fill face where the top of the excavation is within 10 metres of buildings or surcharge points.
- No significant change is to occur to existing flood overflow paths.
- Except when associated with fill faces on rural farm tracks, any fill of over 100 m³ in volume, or 0.5 metres total depth, shall only be permitted if a site plan is provided to Hastings District Council showing the location and extent of the fill.

<sup>&</sup>lt;sup>11</sup> Soil disturbance activities.

## 3. Site description

#### 3.1 Site identification and location

Project construction is proposed to take place in Putorino, Hawke's Bay, New Zealand. Putorino is a small farming settlement located on SH2, approximately 60 km north of Napier, situated between Tutira and Kotemaori. The Alignment transects both several Putorino properties, and the Waikari River (the changeover point of Council jurisdiction). An approximate location (shown in pink) for the 4.22 km Alignment is presented in **Figure 1** below.

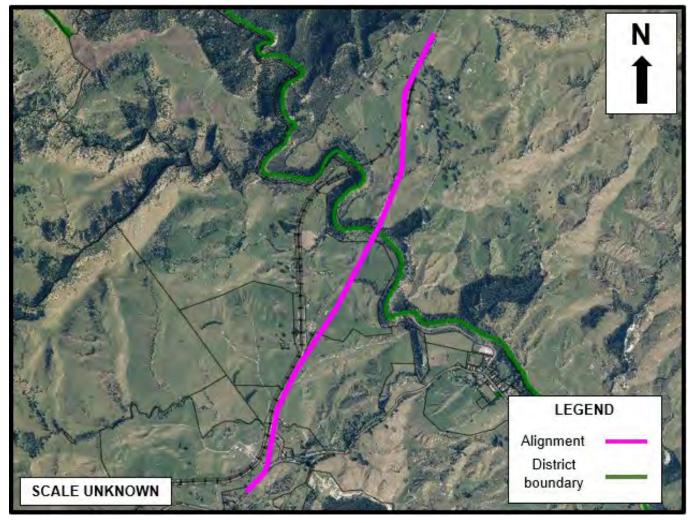


Figure 1 Approximate Alignment location 12

<sup>&</sup>lt;sup>12</sup> Sourced from HDC online mapping services.

**Table 1** below presents details for properties in the vicinity of the Alignment and within the proposed Alignment works (refer to the concept design drawings in **Appendix A**).

Table 1 Details for properties in the vicinity of the Alignment and within the proposed Alignment works<sup>13</sup>

District authority	Address	Legal description	Certificate of Title	Area (ha)	Zone name
WDC	5500 SH2, Putorino, Hawke's Bay	PART LOT 1 DP 13713	HBF4/1448	98.42	Rural Zone
WDC	5517 SH2, Putorino, Hawke's Bay and 5556 SH2, Putorino, Hawke's Bay	PART LOT 1 DP 13541	HBG3/1433	227.82	Rural Zone
HDC	151 Putorino Station Road, Putorino, Hawke's Bay	LOT 1 DP 25330 SEC 22 SO 1621	M2/901, V4/130	199.70	Rural Zone
HDC	5100 SH2, Putorino, Hawke's Bay	LOT 1 DP 9366 LOT 1 DP 21170 LOT 1 DP 23044 LOTS 1 2 DP 24159 LOT 3 DP 25330 LOT 1 DP 26609 SEC 23 SO 1621 SEC 33 PT SEC 34 SO 2516 SEC 41 SO 6201 SEC 51 PT SEC 37 BLK II MOEANGIANGI SD - PUTORINO GOLF CLUB - LAKE HILL STUD -	J1/419, P2/890, C4/1271	326.33	Rural Zone
HDC	5224 SH2, Putorino, Hawke's Bay	LOT 1 DP 23291 BLK VI MOEANGIANGI SD- SUBJ TO & INT IN R/W	P4/388	24.16	Rural Zone

#### 3.1.1 Existing land use and zoning

Existing land use surrounding the alignment was assessed using mapping services provided by WDC and HDC. As discussed in Section 2.2, the Alignment is situated within the Rural Zone as per the Wairoa District Plan and Hastings District Plan. Both plans generally define the Rural Zone as being dominated by agricultural, forestry, and farming related activities.

The land-use surrounding the Alignment is predominantly farming oriented. The land is mostly pastoral with some farm related buildings and sparse residential occupancies.

#### 3.1.2 Proposed works

This Section details a brief summary of the works proposed for construction of the Alignment (refer **Appendix A** for concept design drawings).

As discussed in Section 1.1, the constructed Alignment will consist of a 4.22 km two-lane section of roadway, with northern tie in works situated between 5500 SH2 and 5517/5556 SH2, and southern tie in works situated between 5100 SH2 and 5224 SH2. As part of the proposed works, the following key items are to be constructed (not including the roadway itself):

- Accessways to the Alignment for multiple properties at the east sweeping bend near the northern tie in works.
- Five stormwater structures that transect the Alignment.
- Two stock underpasses, one north, and one south of the Waikari River.
- Two paddock access tracks north of the Waikari River.
- A bridge that crosses over the existing railway line north of the Waikari River with two large retaining walls, one each on opposite sides of the bridge.
- A bridge that spans the Waikari River.
- A hospitality development south of the Waikari River.
- A Waka Kotahi "Type D" accessway that connects the Alignment to Putorino Station Road immediately south
  of the hospitality development.

<sup>&</sup>lt;sup>13</sup> Sourced from WDC and HDC online mapping services.

The following works are to be undertaken on existing key items:

- The realignment of three farm tracks south of the Waikari River.
- The realignment of a stormwater drain, south of the Waikari River and east of the Alignment, to tie in with a new stormwater structure.
- The extension of an existing stormwater structure south of the Waikari River.

At the time of writing, the construction methodologies including proposed soil disturbance and disposal volumes are yet to be confirmed; however, as per the concept design drawings (refer **Appendix A**), the majority of earthworks are proposed as cut and fill, weighted approximately 50% each.

## 3.2 Environmental setting

#### 3.2.1 Geology

A section of the published geological map of the Hawke's Bay area<sup>14</sup> presented in **Figure 2** indicates that the subsurface geology underlying the Alignment is part of the Mangaheia Group. **Table 2** details the geological descriptions derived from published geological map of the Hawke's Bay area.

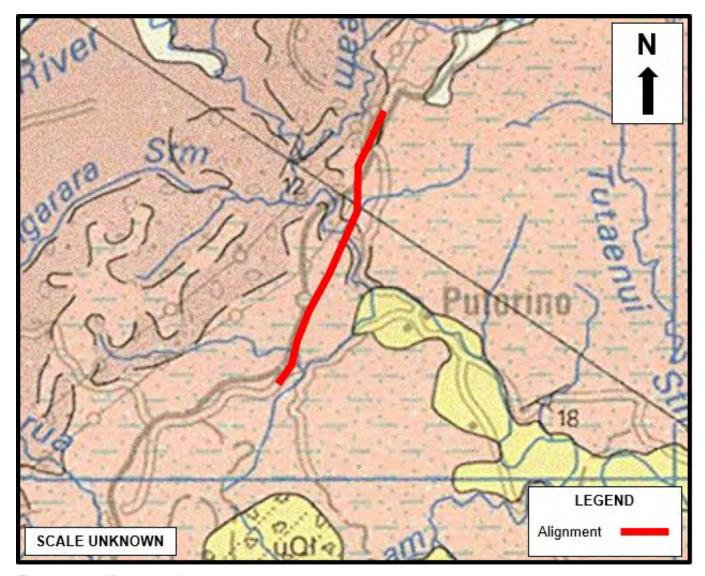


Figure 2 Alignment geology

<sup>&</sup>lt;sup>14</sup> Lee, J.M.; Bland, K.J.; Townsend, D.B.; Kamp, P.J.J. (compilers) 2011: Geology of the Hawke's Bay area. Institute of Geological & Nuclear Sciences 1:250 000 geological map 8. 1 sheet + 93 p. Lower Hutt, New Zealand. GNS Science.

Table 2 Geological descriptions

Map graphic	Geological unit	Geological description
Pmm .	Mangaheia Group	Massive, locally fossilferous mudstone, alternating sandstone and mudstone; tephra beds common.
Pmb	Mangaheia Group (Matahorua Formation)	Alternating sandstone, mudstone and conglomerate.
Pmz	Mangaheia Group	Siltstone, sandstone and minor shell-beds.

#### 3.2.2 Topography, hydrology, and hydrogeology

The topography and hydrology of the area surrounding the Alignment is presented in **Figure 3**. The Alignment is situated in a minor valley on slightly undulating ground where changes in gradient are often gentle. Rolling hills, between 200 to 300 m above sea level (masl) are present on either side (east and west) of the Alignment. At the northern tie in works where the Alignment commences, the ground is situated approximately 160 masl. From these tie in works, the ground gently slopes to 100 masl at the northern bank of the Waikari River. This ground elevation continues along the Alignment from the southern bank of the Waikari River and generally remains unchanged until the conclusion of the Alignment at the southern tie in works. The conclusion of the Alignment has a ground elevation of approximately 110 masl.

As shown in **Figure 3**, the main waterbodies within 500 m of the Alignment are the Waikari River, flowing northwest to southeast, the Pohatanui Stream, flowing south to north, and other tributaries that flow toward the Waikari River. Localised groundwater is anticipated to mimic the topography of the area and flow toward the Waikari River. A bore search was requested of HBRC by GHD as part of a contamination enquiry for the area surrounding the Alignment (refer Section 4.2.1.2). The enquiry identified three bores on properties in the vicinity of the Alignment, two of these being within approximately 200 m of the Alignment, one active, and the other presumed redundant. Refer to Section 4.2.1.2 for further information on these bores. There are no other known sensitive groundwater abstractions within the vicinity of the Alignment.

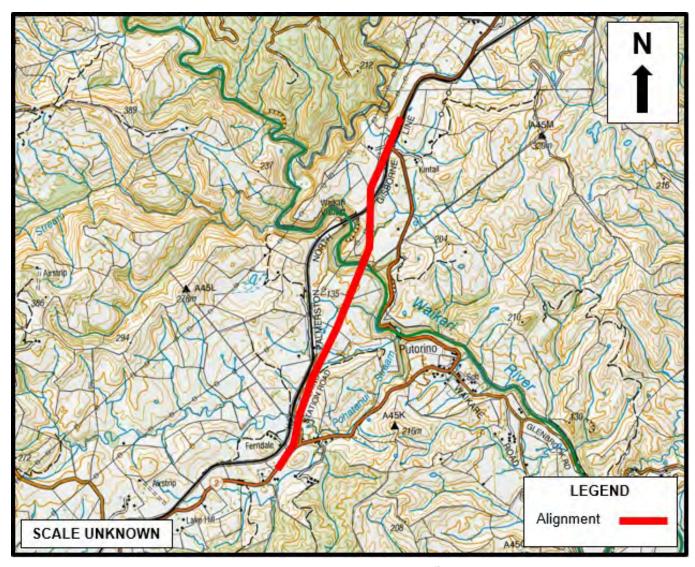


Figure 3 Topography and hydrology of the area surrounding the Alignment<sup>15</sup>

## 3.2.3 Built environment and underground infrastructure

Due to the rural location of the Alignment, there is little to no built environment. The only indications of built environment come in the form of sparse farming related buildings and residential occupancies in the general area. Mapping services provided by HBRC, WDC, and HDC were used to ascertain the presence or absence of asbestos containing underground infrastructure in the area surrounding the Alignment. Upon review, there was no indication of any public underground infrastructure in this area.

<sup>&</sup>lt;sup>15</sup> Sourced from WDC online mapping services.

## 4. PSI

### 4.1 Site history

This Section of the PSI assesses current and historic HAIL activities (if any) that are more likely than not to have occurred within or adjacent to the Alignment, based on historical aerial imagery.

#### 4.1.1 Historical aerial image review

The assessments in this review were based on historical aerial imagery sourced from Retrolens Historical Aerial Imagery Resource (Retrolens) <sup>16</sup>, and Land Information New Zealand (LINZ)<sup>17</sup>. These sources provided images for select years from 1945 through to 2020 with a reasonable degree of clarity. The historical aerial image review (discussed in greater detail) is provided in **Appendix B**. Section 4.1.2 below details a summary of the historical aerial image review.

#### 4.1.2 Historical aerial review and land use summary

As part of the historical aerial review, it was noted that land use along the proposed Alignment and the area that surrounds it has been predominantly associated with rural activities from 1945 through to current times. It is evident that farming has consisted most of these rural-based activities in the general area.

From 1945 the land that surrounds the Alignment has remained largely undeveloped. The small volume of development in the area was noted as sparse residential occupancies and farming related buildings. From 1945 there has generally been a slow and steady increase in farming related activities in the area, for example: through the erection of milking sheds and other farming related buildings.

As a result of the historical aerial image review, no potential HAIL activities were identified as having more likely than not occurred on land in the vicinity of the Alignment

#### 4.2 Council information

This Section discusses relevant site contamination information received and/or retrieved from HBRC, WDC, and HDC. All information received and/or retrieved from these councils are compiled together and provided in **Appendix C**.

#### 4.2.1 HBRC

GHD requested available site contamination information in the form of an enquiry with the HBRC contaminated land team. Site contamination information (including relevant resource consents) for all properties and land parcels listed in **Table 1** was requested as part of this enquiry. The key findings of this enquiry are summarised in the following Sections.

#### 4.2.1.1 HAIL information

HBRC records indicate that land parcel Part Section 37 Block II, Section 51 Block II Moeangiangi, at 5257 SH2 (5100 SH2 in **Table 1**) has been subject to the following HAIL activity:

HAIL Category F4: Motor vehicle workshops.

This land parcel is situated east of the Alignment, approximately 75 m from the assumed extent of soil disturbance works (refer Section 4.4.2), and approximately 5 m from supplementary works (the full context and scope of which is unknown to GHD) titled 'reform to create property access' (refer to the concept design drawings in **Appendix A**).

HBRC records in relation to this land parcel indicate that a motor vehicle workshop was located at this site from 1981 to 2002 which included two fuel storage tanks. The tanks were noted as removed in 2002, each being 4545

<sup>16</sup> www.retrolens.co.nz

<sup>17</sup> www.data.linz.govt.nz

litres (L) in volume. HBRC were unable to confirm the contents of these tanks and their storage conditions (above or below ground) or provide any reports confirming investigations or sampling undertaken.

#### 4.2.1.2 Bore consents

HBRC provided the following information on bore resource consents within the area of enquiry:

- Water Take Consent (AUTH-108259-01) to take water from Well No. 2054 (0.1 m diameter) to irrigate golf course greens. This consent was held for land parcel Part Section 34 SO 2516 of 5100 SH2 (refer **Table 1**) and expired in 2008. A HBRC bore log for this well indicates it was drilled in 1986, with a total depth of 85.34 m below ground level (mbgl), and a screen situated between 42.6 and 60.9 mbgl. The location of this expired well (presumed redundant) is depicted in **Figure 4** below.
- Bore Permit (AUTH-114593-01) to drill a 0.1 m diameter bore (Well No. 5337) for domestic/stock water purposes. This consent is held for land parcel Lot 1 DP 25330 at 151 Putorino Station Road (refer **Table 1**). A HBRC bore log for this well indicates it was drilled in 2005 with a total depth of 68 mbgl, and a screen situated from 44 to 68 mbgl. The location of this active well is depicted in **Figure 4** below.
- Bore Permit (AUTH-113877-01) to drill a 0.05 m diameter bore (Well No. 5129) for monitoring purposes. This
  consent is held for land parcel Part Lot 1 DP 13541 at 5556 SH2 (refer **Table 1**). As this bore was likely drilled
  for exploratory monitoring purposes, there was no bore log or locality information available.

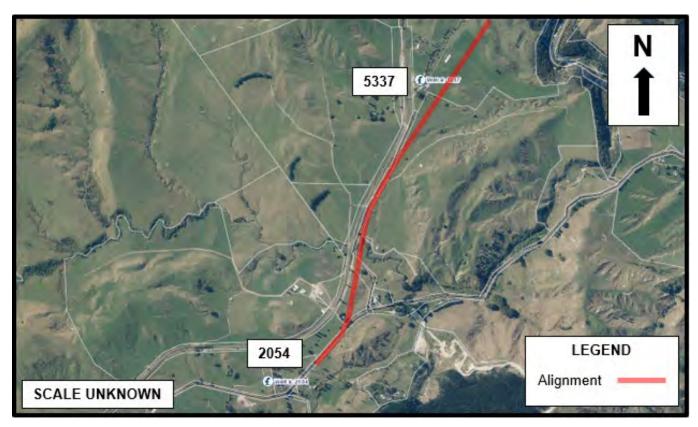


Figure 4 Locations of known wells<sup>18</sup>

#### 4.2.1.3 Discharge consents

The information provided by HBRC indicates that there are two active discharge consents within the area of enquiry. One each is held by two separate land parcels under the same address of 5100 SH2 (refer **Table 1**), both of which are in the vicinity of the Alignment. HBRC records revealed that both consents relate to the discharge of dairy farm effluent onto land. As these discharge consents do not indicate the presence of any HAIL activities, these files were not reviewed.

<sup>&</sup>lt;sup>18</sup> Image sourced from HBRC online mapping services.

#### 4.2.2 WDC

GHD requested available site contamination information in the form of an enquiry with WDC. Site contamination information (including relevant resource consents) for all properties and land parcels under WDC jurisdiction (north of the Wakari River) listed in **Table 1** was requested as part of this enquiry. In response, WDC were unable to prepare a report similar to that of the HBRC contaminated land team (refer Section 4.2.1); however, did provide some documentation.

The documentation provided by WDC revealed nothing of note. It did not contain any HAIL information or contamination relevant resource consents for the enquired properties or of those nearby.

#### 4.2.3 HDC

GHD requested available site contamination information in the form of an enquiry with HDC. Site contamination information (including relevant resource consents) for all properties and land parcels under HDC jurisdiction (south of the Wakari River) listed in **Table 1** was requested as part of this enquiry. In response, HDC were unable to prepare a report similar to that of the HBRC contaminated land team (refer Section 4.2.1); however, did allow GHD access to their online property file access server<sup>19</sup>. During the course of this PSI, GHD accessed this server to search for property files pertaining to land in the vicinity of the Alignment. As a result of this search, GHD discovered one relevant document pertinent to the PSI which is detailed in following Section 4.2.3.1.

#### 4.2.3.1 HAIL information

The document retrieved was a tank removal checklist (property file reference: 50174#0005) dated the 18<sup>th</sup> of July 2002 which GHD linked to the tanks referred to in the HBRC site contamination enquiry report (refer Section 4.2.1.1). These tanks were removed from Part Section 37 Block II, Section 51 Block II Moeangiangi, at 5257 SH2 (5100 SH2 in **Table 1**). This land parcel is situated east of the Alignment, approximately 75 m from the assumed extent of soil disturbance works (refer Section 4.4.2), and approximately 5 m from supplementary works (the full context and scope of which is unknown to GHD) titled 'reform to create property access' (refer to the concept design drawings in **Appendix A**).

The document indicated the following:

- HAIL Category A17: Storage tanks or drums for fuel, chemicals or liquid waste, has occurred at this property.
- Both tanks were stored underground; one tank contained diesel, and the other petrol.
- Generally, no contamination was noted upon removal; however, a slight hole in bottom of the diesel tank had led to some discharge, and therefore approximately 2 m³ of soil was subsequently removed as result.
- A soil sample was collected; however, the suite of analysis or results of any testing were not provided in the document.

#### 4.3 Miscellaneous information

During feasibility walkovers of the Alignment, WSP New Zealand Limited (WSP) noted two silage pits near the southern tie in works, where the Alignment is situated immediately adjacent the railway line. WSP informed GHD of these silage pits before works under this PSI commenced. GHD noted what appeared to be silage areas from 2003 onwards in the historical aerial image review (refer **Appendix B**). These silage areas were confirmed to be the pits WSP had noted during feasibility walkovers. As silage-based activities don't fall under the HAIL, these silage pits are not discussed further in this PSI.

#### 4.4 Summary

### 4.4.1 Risk ratings

GHD has considered potential risks to human health and the environment in relation to construction of the proposed Alignment through soil disturbance activities. GHD has created arbitrary risk ratings to be considered

<sup>19</sup> www.propertyfiles.hdc.govt.nz

when these works take place in the presence of HAIL activities. These risk ratings and their definitions are outlined in **Table 3**.

Table 3 Risk ratings and their definitions

Risk rating	Definition
Low	Current or historic HAIL activities are situated 200 m or further from the proposed Alignment and a complete contaminant transport pathway between potentially contaminated soils and the proposed Alignment has been considered unlikely to present a significant risk to the proposed works.
Low to medium	Current or historic HAIL activities are situated within 200 m of the proposed Alignment. Due to the proximity and nature of HAIL activities there is a potential that contamination may be encountered during the proposed works. Further investigation should be considered.
Medium	Current or historic HAIL activities are adjacent to the proposed Alignment. Due to the proximity and nature of HAIL activities there is a potential that contamination may be encountered during the proposed works. Further investigation should be considered.
High	Current or historic HAIL activities are occurring or have occurred within the proposed Alignment. Further investigation should be undertaken.

#### 4.4.2 HAIL activities identified and risk ratings

The following HAIL activities listed in **Table 4** have been identified within the vicinity of the Alignment. Each HAIL activity has been assigned a risk rating (refer Section 4.4.1). These risk ratings are based on HAIL activity proximity to the Alignment and the perceived potential for HAIL activities to impact soils in the proposed soil disturbance work areas.

Table 4 Identified HAIL activities and their risk ratings

HAIL Category	Site specific potential contaminants of concern	Source of info.	Rationale	Address	Approx. distance to Alignment works (refer Appendix A)	Location ref. (refer Figure 5)	Risk rating
A17	Total petroleum hydrocarbons (TPH), polycyclic aromatic hydrocarbons (PAH), BTEX <sup>20</sup> , various solvents, heavy metals.	HDC	Tank removal checklist identified for this property during a search of the HDC online property file access server.	5100 SH2 (or 4 Putorino	5 m to     supplementary     works titled     'reform to create     property     access' <sup>21</sup> .		
F4		HBRC	HBRC records indicate that this property had a motor vehicle workshop operating on it between the years of 1981 and 2002.	Station Road), Putorino, Hawke's Bay, New Zealand	- 75 m to the assumed extent of soil disturbance works.	1	Low to medium

The locations of HAIL activities identified in **Table 4** above are presented in **Figure 5** below.

<sup>&</sup>lt;sup>20</sup> Benzene, Toluene, Ethylbenzene, and Xylene.

<sup>&</sup>lt;sup>21</sup> The full context and scope of these works are unknown to GHD.

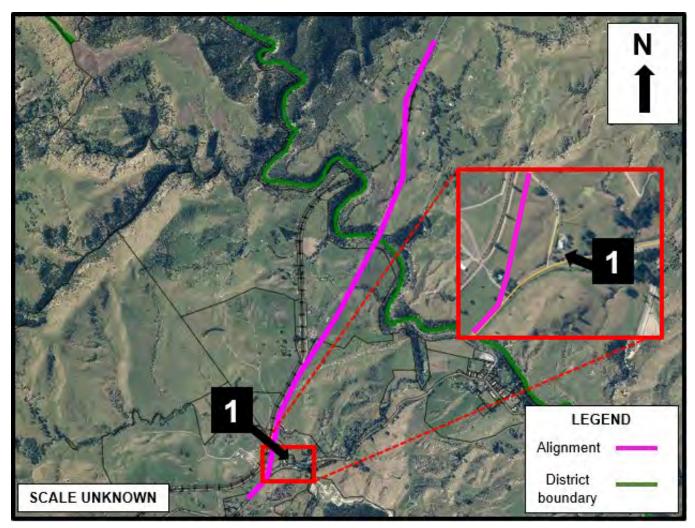


Figure 5 Locations of HAIL activities

#### 4.4.3 Preliminary Conceptual Site Model

A Conceptual Site Model (CSM) is used to communicate information about a site where contamination may pose a risk to human health and/or the environment. Based on the concept designs drawings provided in **Appendix A**, supplementary works (the full context and scope of which is unknown to GHD) and soil disturbance works are proposed approximately 5 m and 75 m respectively from a HAIL Category A17 / F4 site situated at 5100 SH2 (or 4 Putorino Station Road). The CSM presented in **Table 5** provides details of this source of contamination near the Alignment, the pathways these contaminants could travel through, and the potential receptors they could affect.

Table 5 Preliminary CSM

Location	Primary sources	Exposure pathways	Sensitive receptors	Status
	Hydrocarbons, solvents, heavy metals	Dermal contact, ingestion, inhalation	Alignment Project workers, surrounding residents, members of public	Supplementary works 5 m from identified HAIL site: Pathways to receptors likely complete due to proximity; however, the full context and scope of these works is currently unknown to GHD. This status may be reconsidered once further and pertinent information is received and reviewed.
5100 SH2 (or 4 Putorino Station Road), Putorino, Hawke's Bay, New Zealand (see <b>Table 4</b> and <b>Figure 5</b> )		Sediment laden contaminated runoff	Wakari River and Pohatanui Stream	- Soil disturbance works 75 m from identified HAIL site: Pathways to receptors likely incomplete due to proximity. Further investigation (sampling) should be considered prior to the undertaking of Alignment works to further refine this status.  Soil sampling may be undertaken to inform disposal requirements during the works.  To manage potential contamination risks during the proposed works, a Project-specific Contaminated Land Management Plan (CLMP) should be prepared.
		Direct contact with or ingestion of groundwater	Alignment Project workers if groundwater encountered during works, end users of Well No. 5337 (stock)	Where dewatering is planned, further investigation by a hydrogeologist (groundwater sampling) should be considered prior to the commencement of Alignment works in the vicinity of the known HAIL site, as the HAIL Categories are known to cause groundwater contamination. Groundwater sampling may be carried out to inform dewatering disposal requirements during the works.

## 5. Conclusions and recommendations

## 5.1 Summary of findings

This PSI has identified two HAIL activities that have occurred near the proposed Alignment. Each HAIL activity has been assigned a risk rating of low to medium. These risk ratings are based on HAIL activity proximity to the Alignment and the perceived potential for said HAIL activity to impact soils in the proposed soil disturbance work areas.

These activities identified by the PSI were of HAIL Categories A17 and F4, both having occurred between 1981 and 2002 at 5100 SH2 (or 4 Putorino Station Road), Putorino, Hawke's Bay, New Zealand. These activities occurred distances of approximately 5 m from proposed supplementary works (the full context and scope of which is unknown to GHD) and 75 m from the main soil disturbance works. Therefore, a potential exists that soil and groundwater has been contaminated in these areas. Based on the available information assessed during this PSI, it is unclear if the migration of potential contamination from this property has been sufficient to present a risk to human health or the environment in the proposed work areas of the Alignment. As discussed in Section 4.4.3, further investigation in these areas and the consultation of a hydrogeologist should be considered before undertaking proposed Project works (refer **Appendix A**) in these areas.

## 5.2 Statutory implications and likely resource consent requirements

As HAIL activities have been identified as having likely occurred adjacent to the proposed work areas of the Project, the NESCS may apply depending on the scope and nature of soil disturbance works in this area. Based on the potential scale of the proposed works, the Project may not meet the permitted activity thresholds (refer Section 4) within the NESCS, HBRRMP, Wairoa District Plan, and Hastings District Plan for soil disturbance and removal / disposal. If this is the case, a resource consent would be required under the NESCS, HBRRMP, Wairoa District Plan, and Hastings District Plan for the proposed Project works.

Where a resource consent is required, a DSI could be used to inform an application under the HBRRMP, Wairoa District Plan, and Hastings District Plan. In terms of the NESCS, a DSI could also be used to inform a controlled or restricted discretionary consent application. Alternatively, a discretionary consent under the NESCS could be sought without initially completing a DSI. In all instances, a CLMP including unexpected contamination discovery protocol would require generation to support the consent process.

The assumptions and conclusions described above, should be reviewed once the extent and volume of earthworks required for the Project have been confirmed.

#### 5.3 Recommendations

Based on the PSI undertaken and the available information relating to proposed soil disturbance works associated with the Project, GHD make the following recommendations<sup>22</sup>.

#### 531 CIMP

Based on the nature of planned works (soil disturbance) and identified potential contamination issues, it is expected that the identified potential adverse effects to Project workers and surrounding human / environmental receptors could be managed through the implementation of a CLMP.

The purpose of a CLMP is to provide a guide for site workers to manage potential contamination issues during works. These issues include protocols for the management of potentially impacted soils and the protection of human health and the environment in the event of accidental discovery of contaminants. The CLMP would also be used in any resource consent application process.

<sup>&</sup>lt;sup>22</sup> These recommendations should be reviewed once the extent and volume of earthworks required for the Project have been confirmed.

Where investigations prior to planned soil disturbance works are not undertaken, the CLMP should contain provisions regarding soil sampling being conducted during the proposed works to inform soil management controls and soil reuse / disposal requirements. The CLMP could be supported by the completion of a DSI, particularly in areas where HAIL activities have been identified in proximity to proposed Project works during this PSI.

#### 5.3.2 Further investigation

GHD recommends further investigation (soil sampling) be undertaken where works are to be conducted in proximity of HAIL activities identified during this PSI. GHD also recommends a hydrogeologist be consulted with regard to potential groundwater contamination arising from these HAIL activities. A hydrogeologist would also be able to provide guidance on dewatering and groundwater disposal requirements if required.

GHD further recommends investigation be undertaken generally across the Alignment to:

- Support any applications for resource consent.
- Characterise soil conditions and any contamination not identified in this PSI to assist in the development of a Project-specific CLMP.
- Inform options for soil disposal and/or reuse.
- Identify if groundwater is likely to be encountered during the works.
- Inform construction methodology.

Undertaking further investigations generally across the Alignment would assist in streamlining construction activities; providing clarity on management methods (e.g. soil disposal location) prior to the commencement of excavation.

## Appendices

## Appendix A

Alignment concept design drawings



# WAKA KOTAHI NZ TRANSPORT AGENCY WAIKARE GORGE REALIGNMENT

## **CONCEPT DESIGN**

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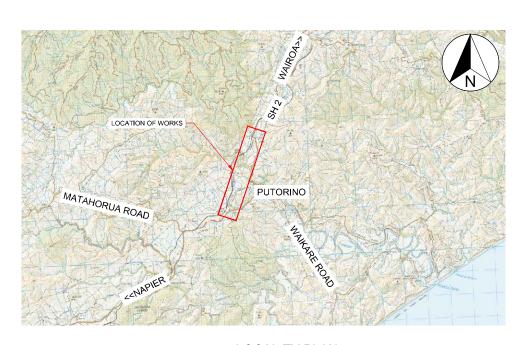
#### SHEET INDEX

0001 - OVERALL PLAN, LOCALITY AND SHEET INDEX

0002 - 0009 PLAN AND LONGSECTIONS

C120 - C129 PAVEMENT AND TYPICAL SECTIONS

C150 - C195 CONSTRUCTION CROSS SECTIONS



## $\frac{\text{LOCALITY PLAN}}{\text{SCALE N.T.S.}}$

REVISION AMENDMENT APPROVED DATE



Napier Office +64 6 833 5100

Private Bag 6019 Napier 4142 New Zealand

TRANSPORT

SCALES
AS SHOWN

DRAWN
DESIGNED
A. LEWIS

DRAWING VERIFIED
DRAWING VERIFIED
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J. TAYLOR

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**CONCEPT DESIGN** 


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OVERALL PLAN, LOCALITY AND SHEET INDEX


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REVISION	AMENDMENT	APPROVED	DATE



Napier Office +64 6 833 5100

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Private Bag 6019 Napier 4142 New Zealand

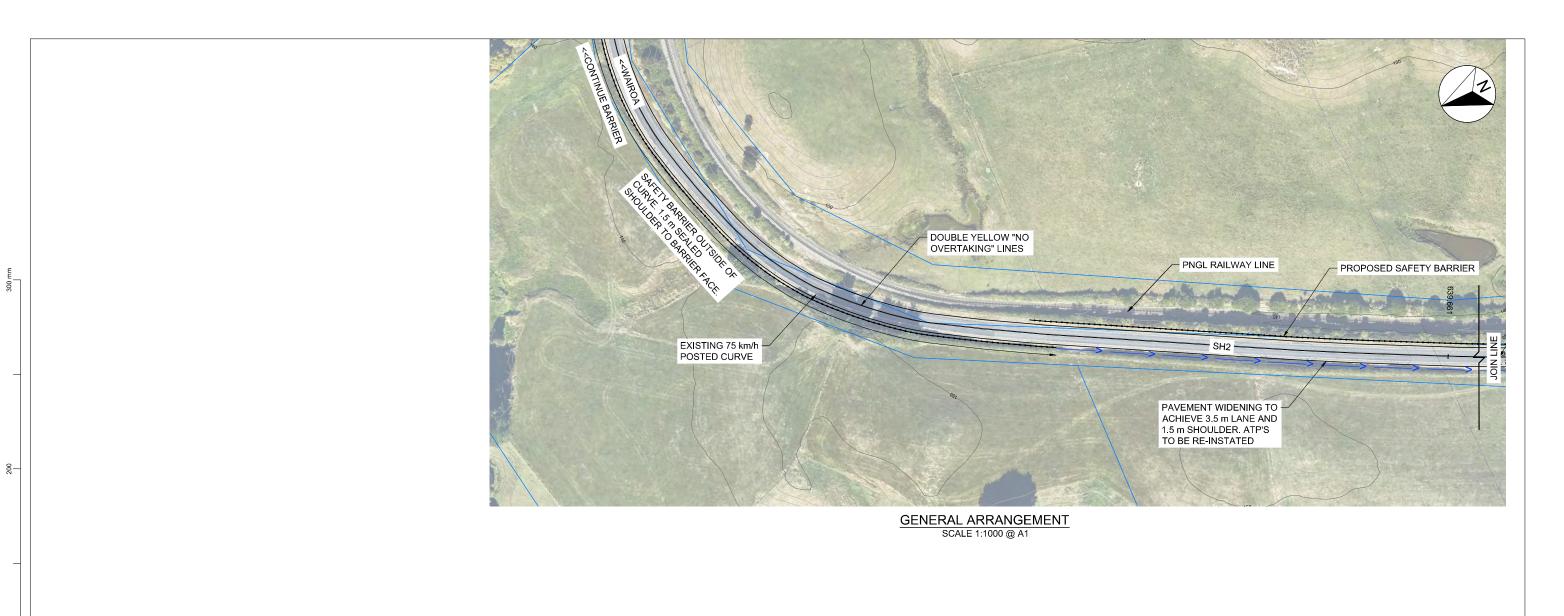CONCEPT DESIGN

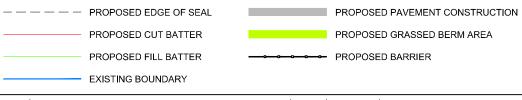WAKA KOTAHI NZ TRANSPORT AGENCY SH2 R.P. 577/11.600-592/2.500 WAIKARE GORGE REALIGNMENT

0002

GENERAL ARRANGEMENT
PLAN AND LONGSECTION SHEET 1 OF 8

PLAN AND LONGSECTION SHEET 1 OF 8


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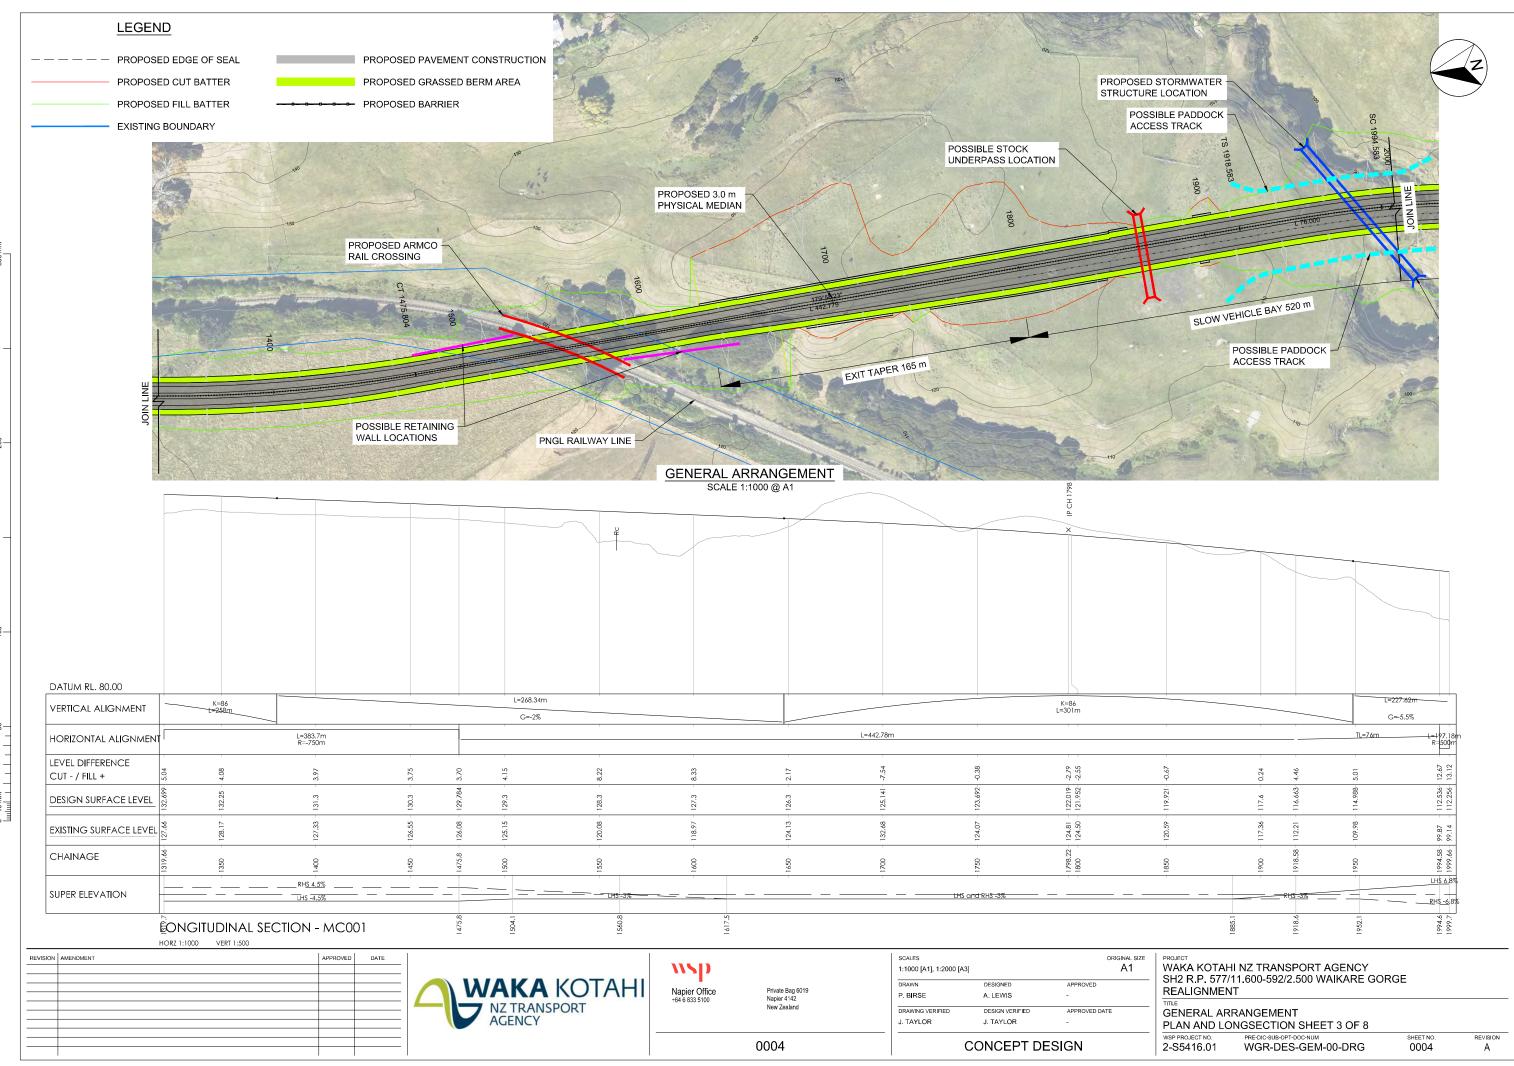
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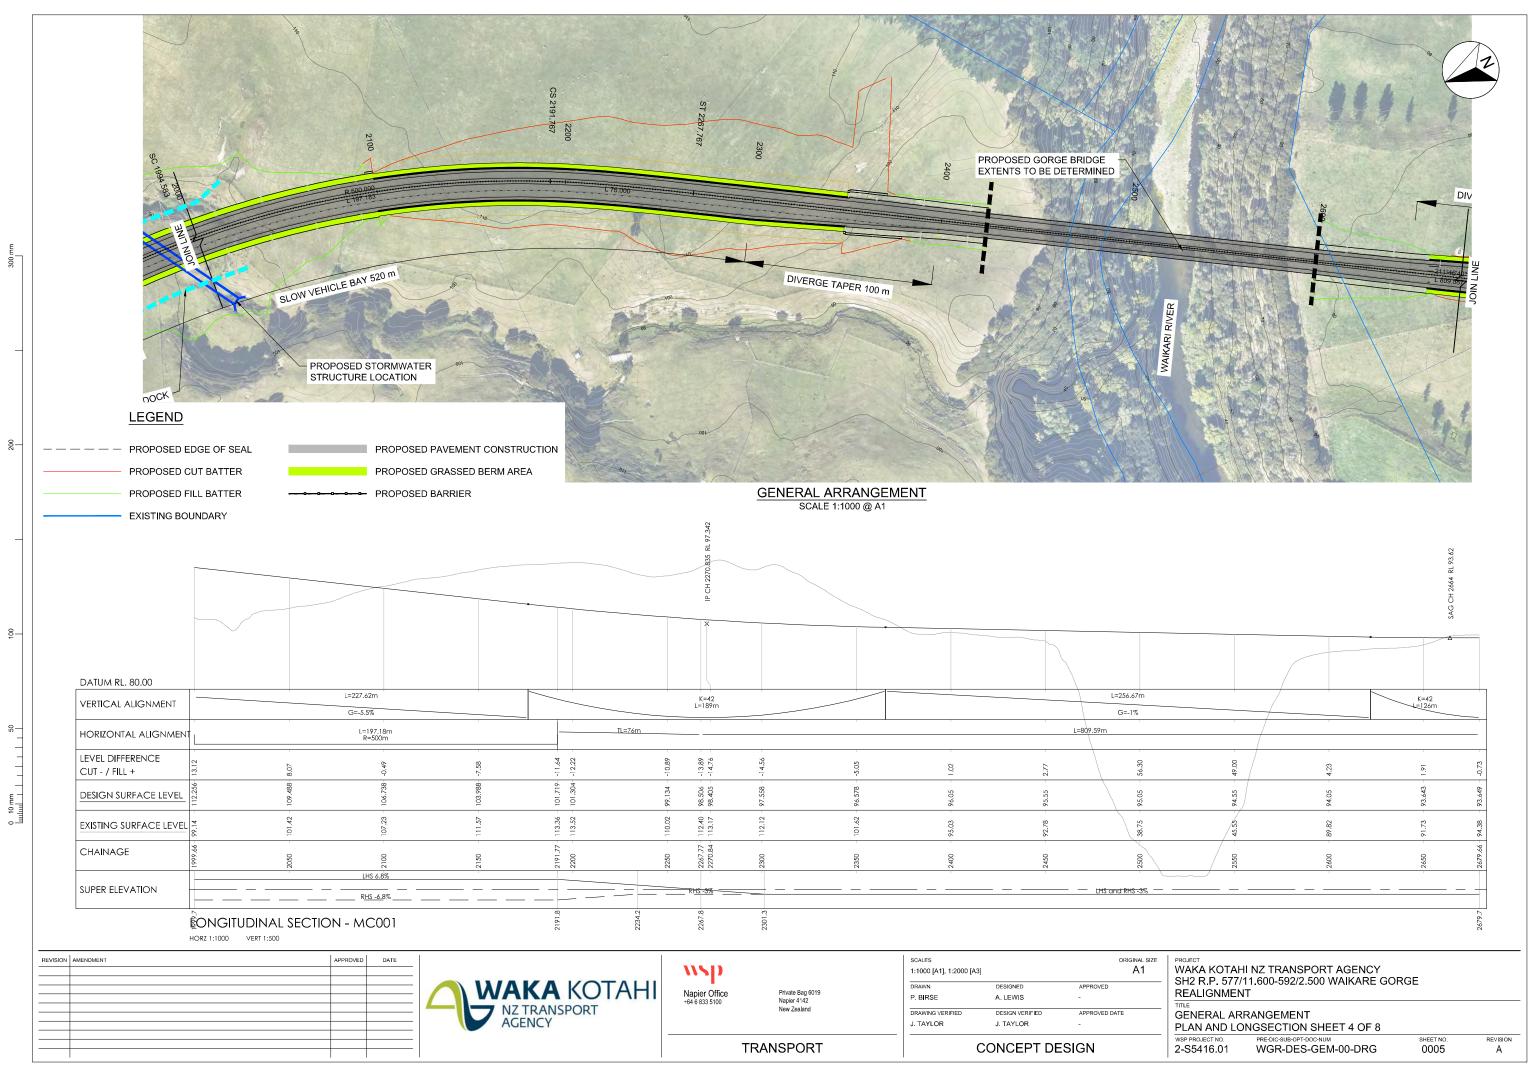
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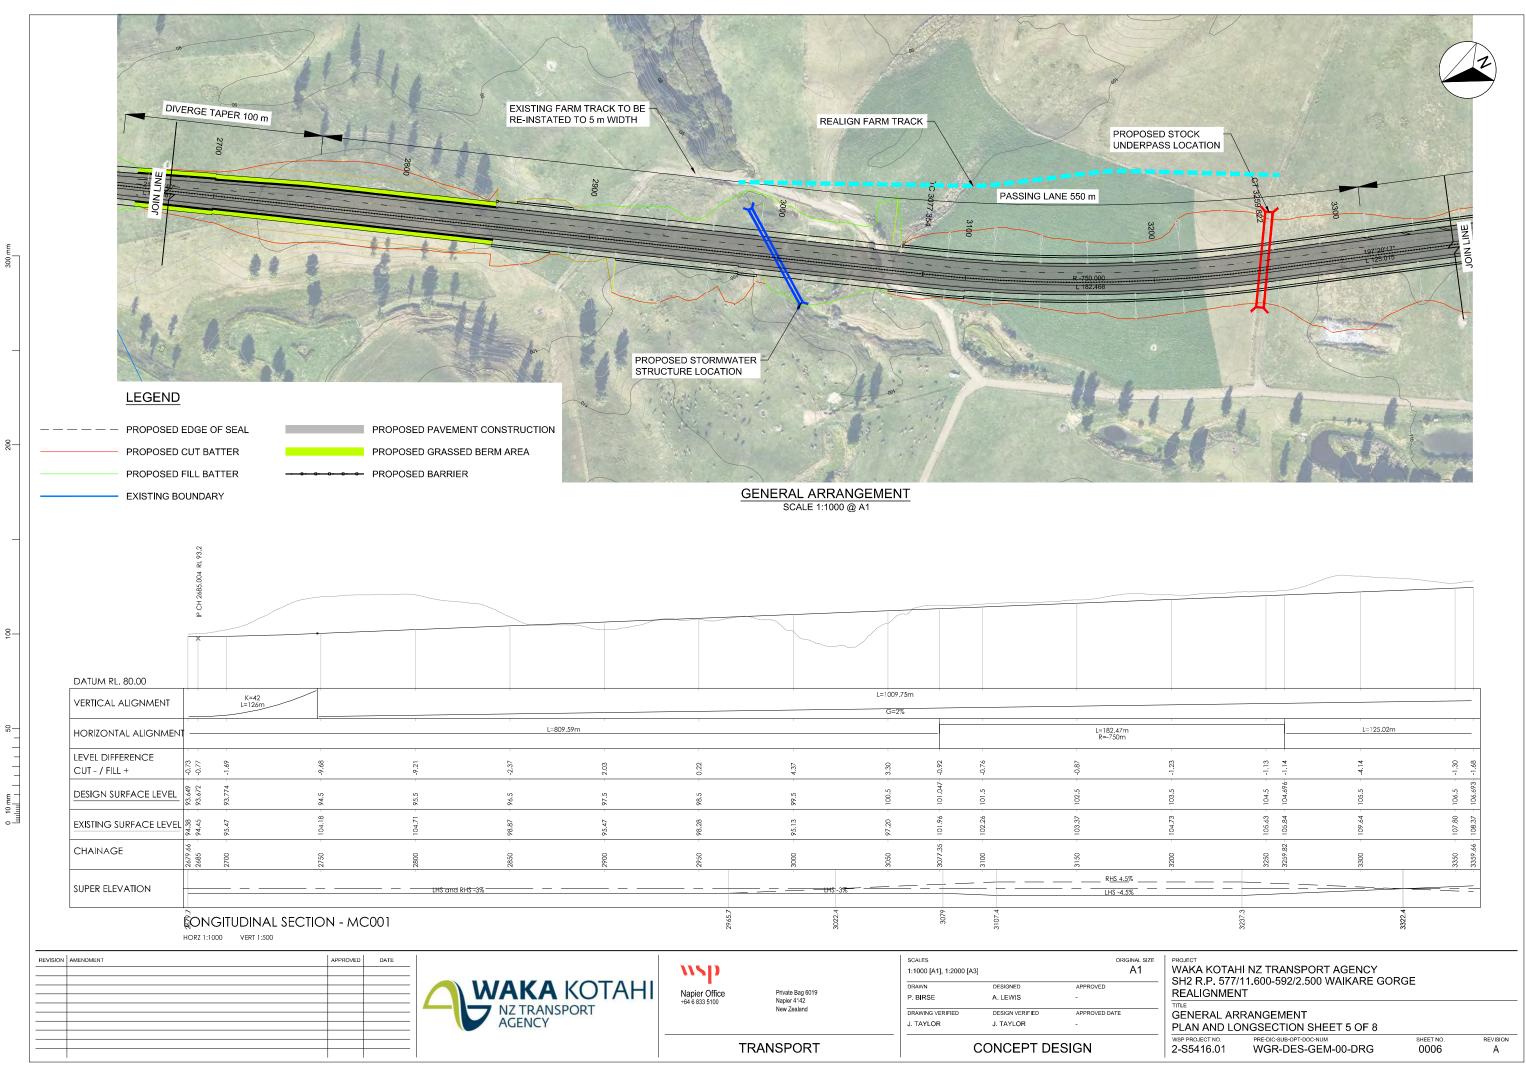
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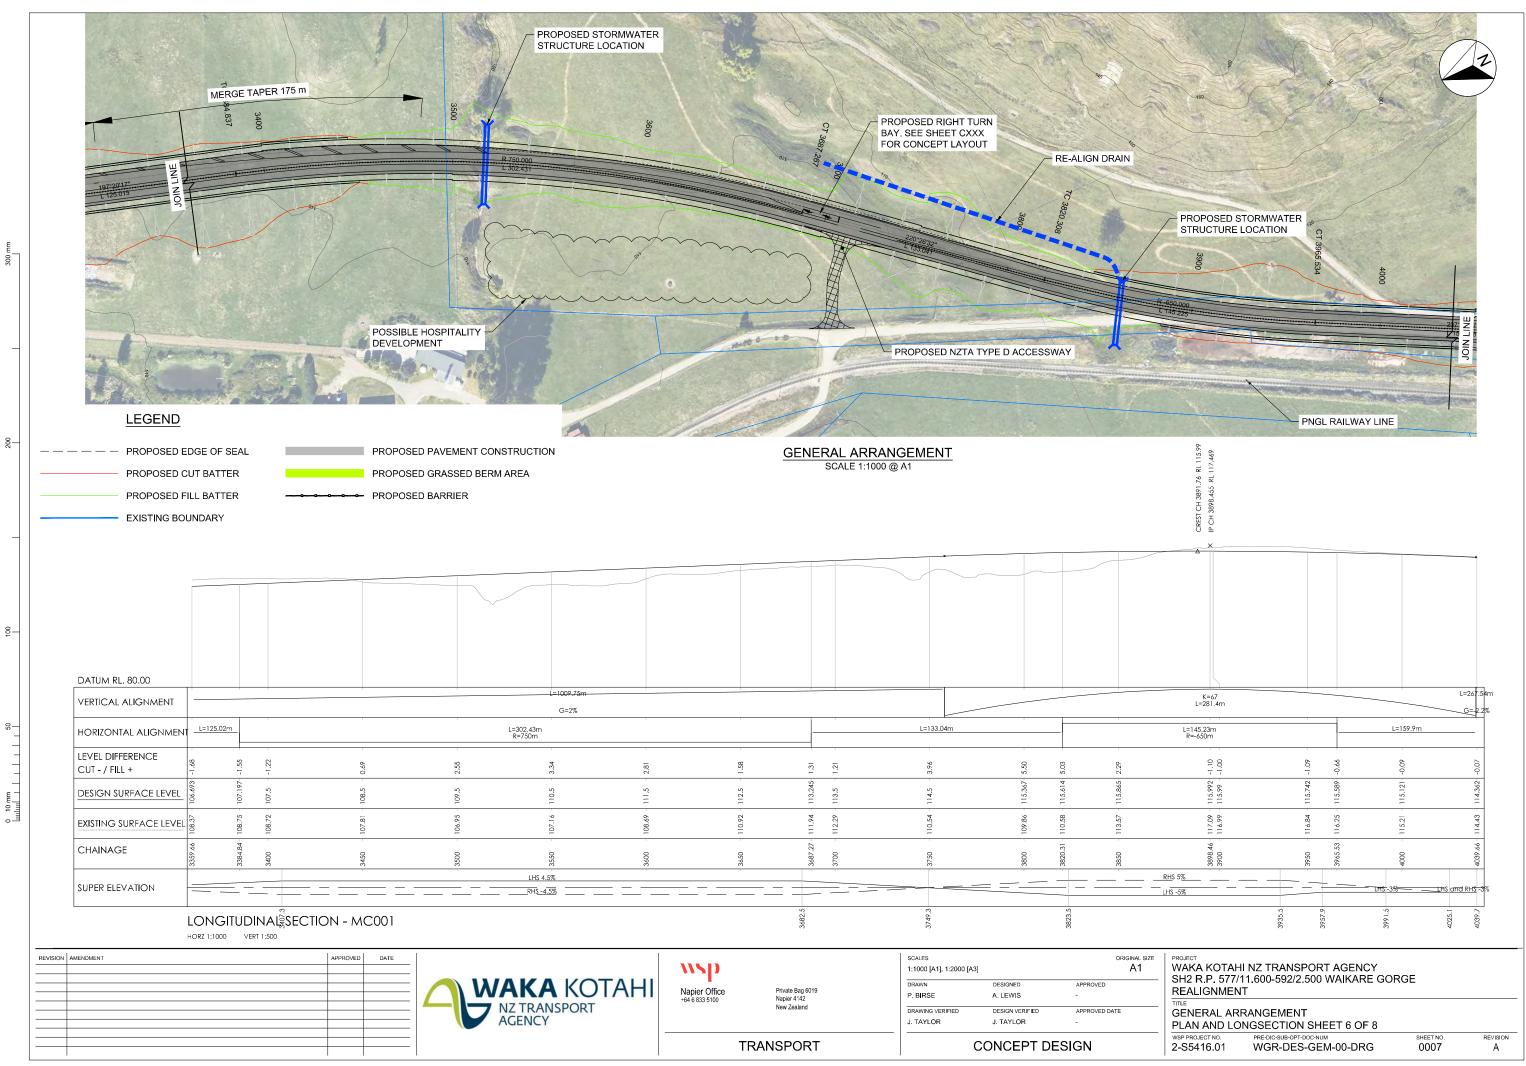
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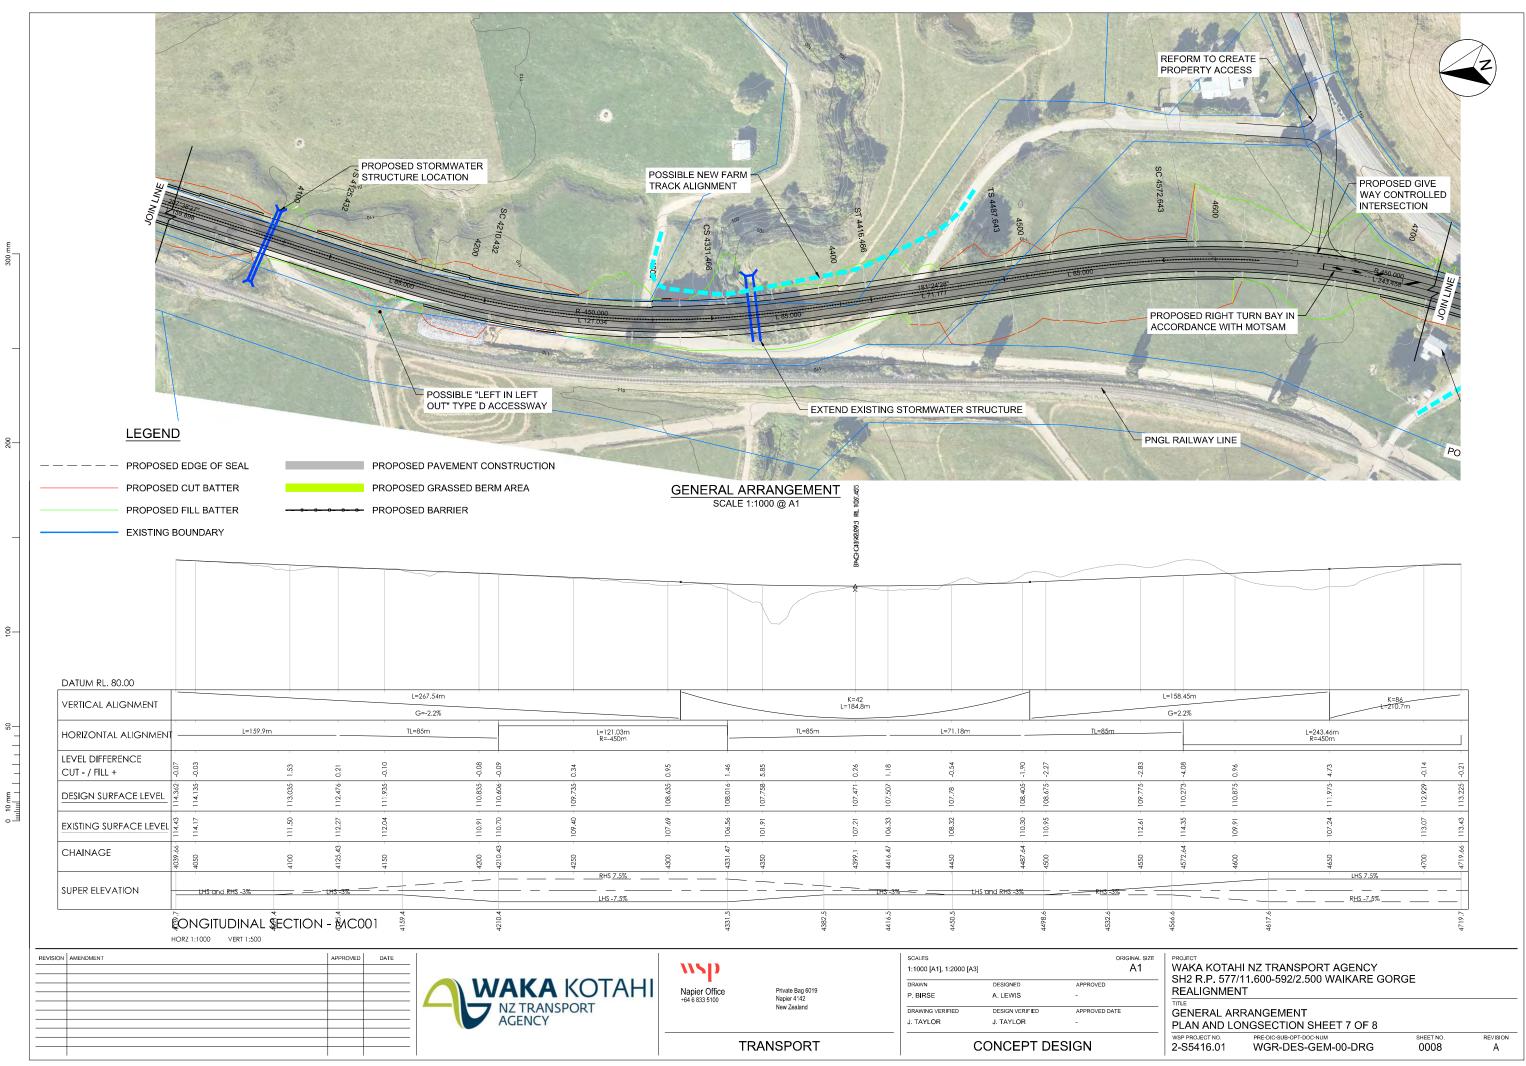














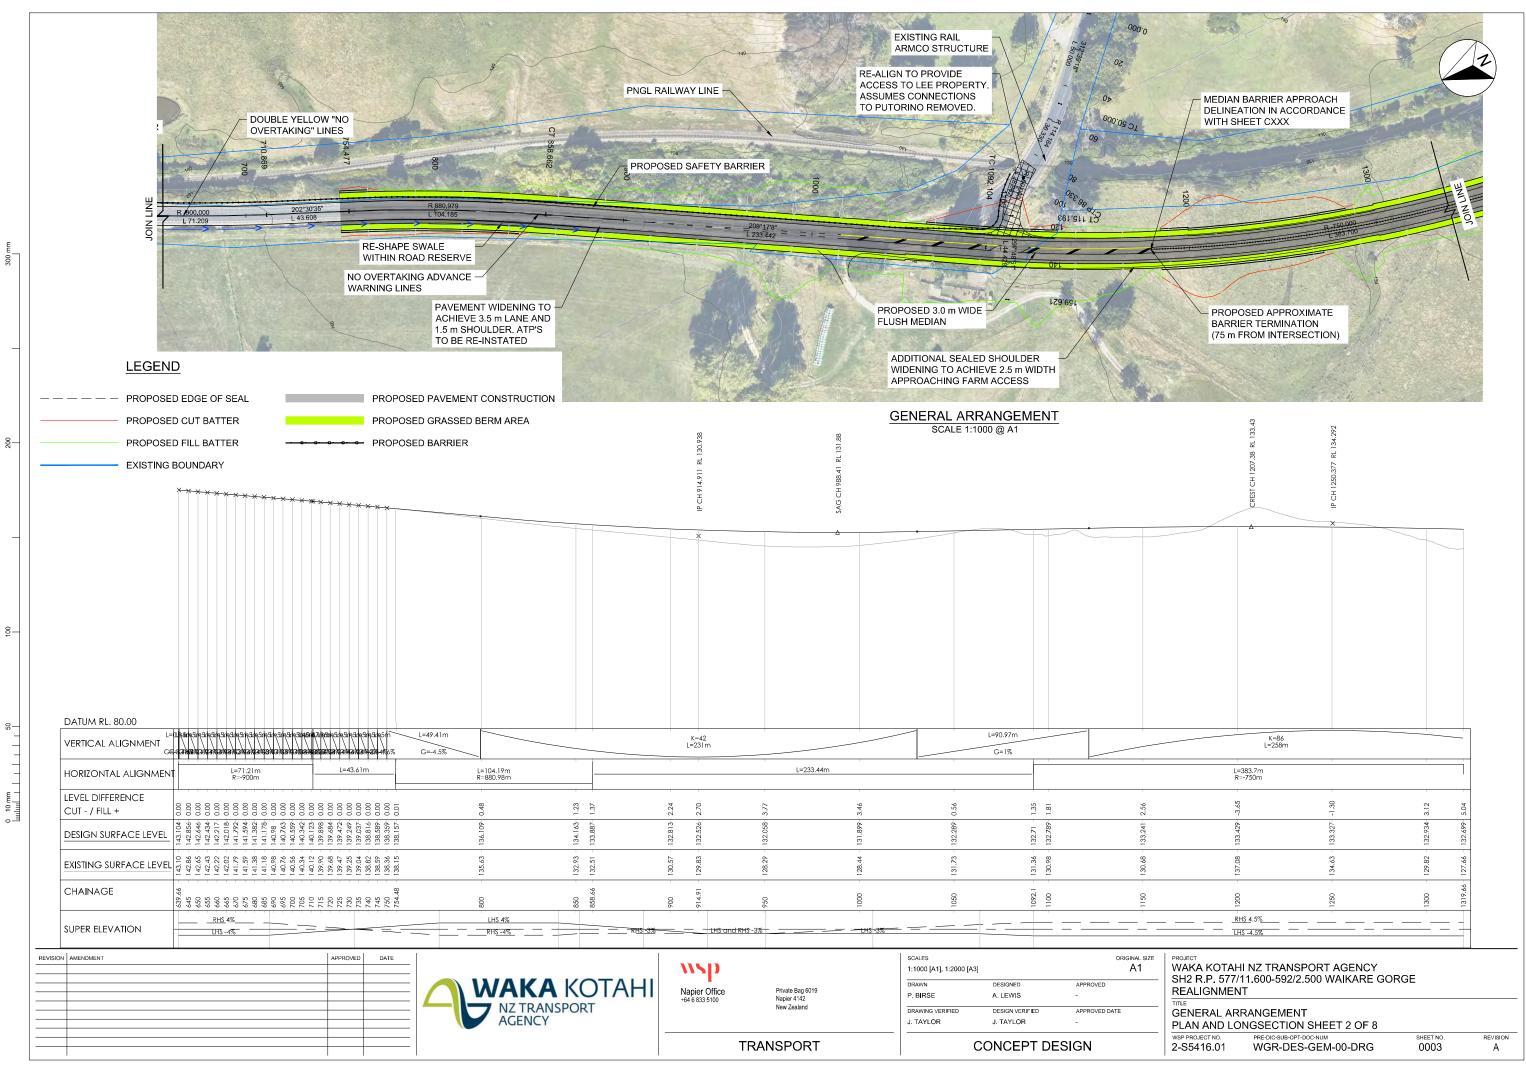


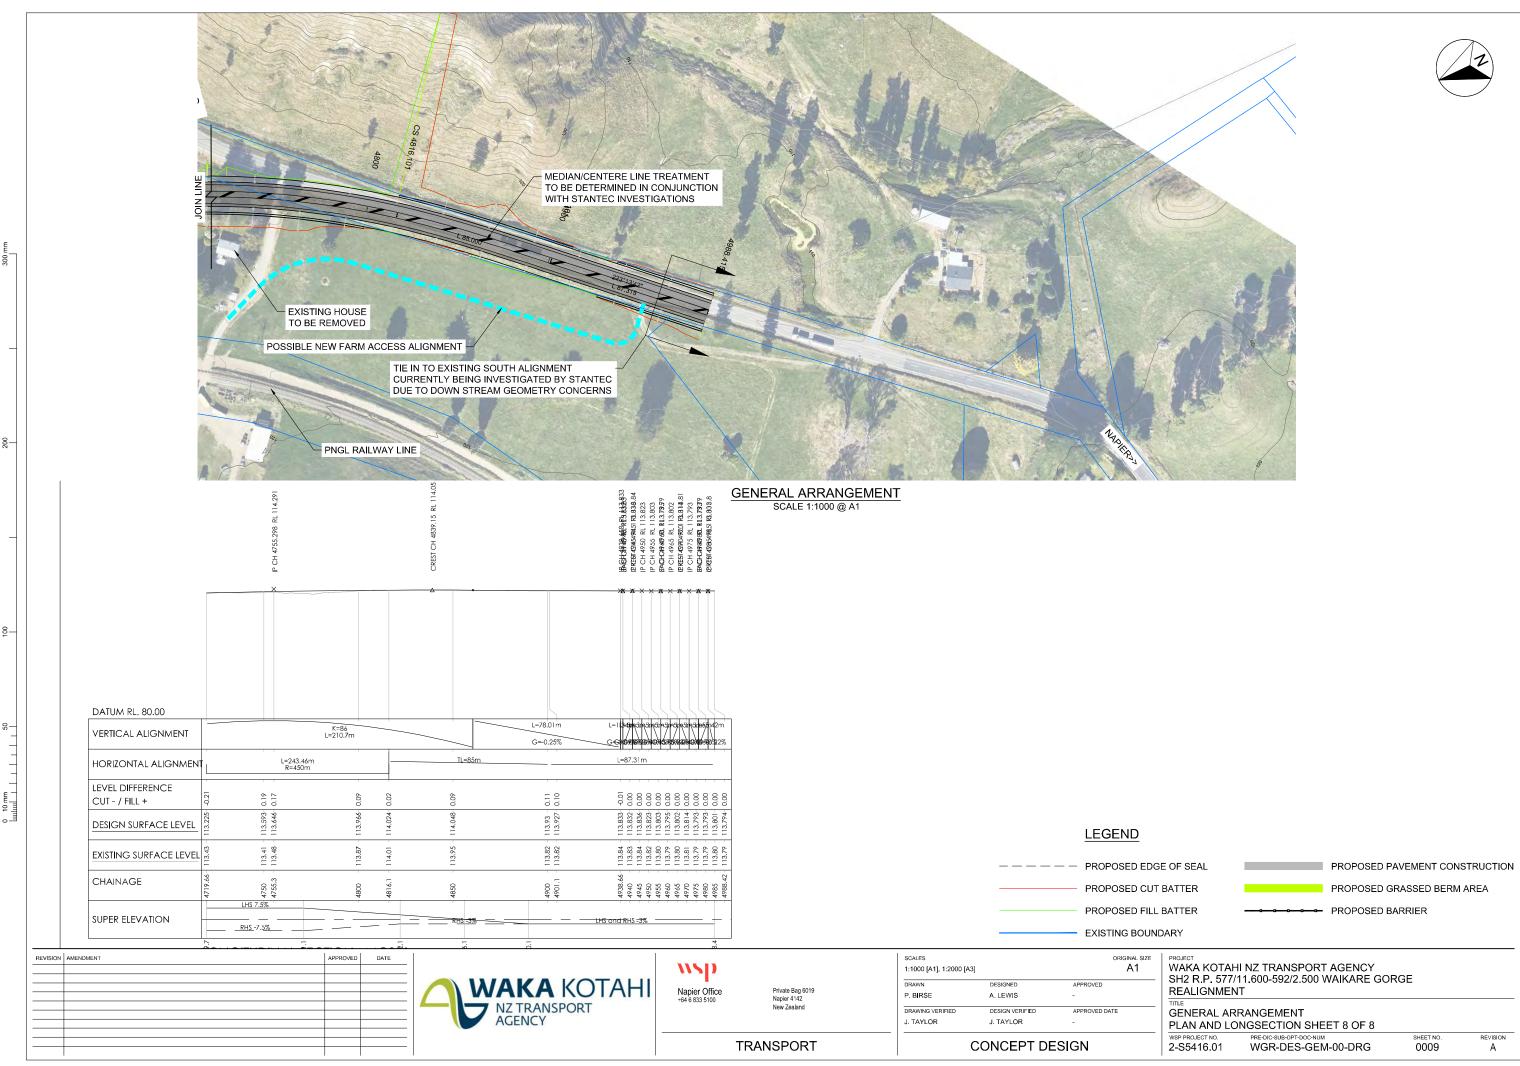


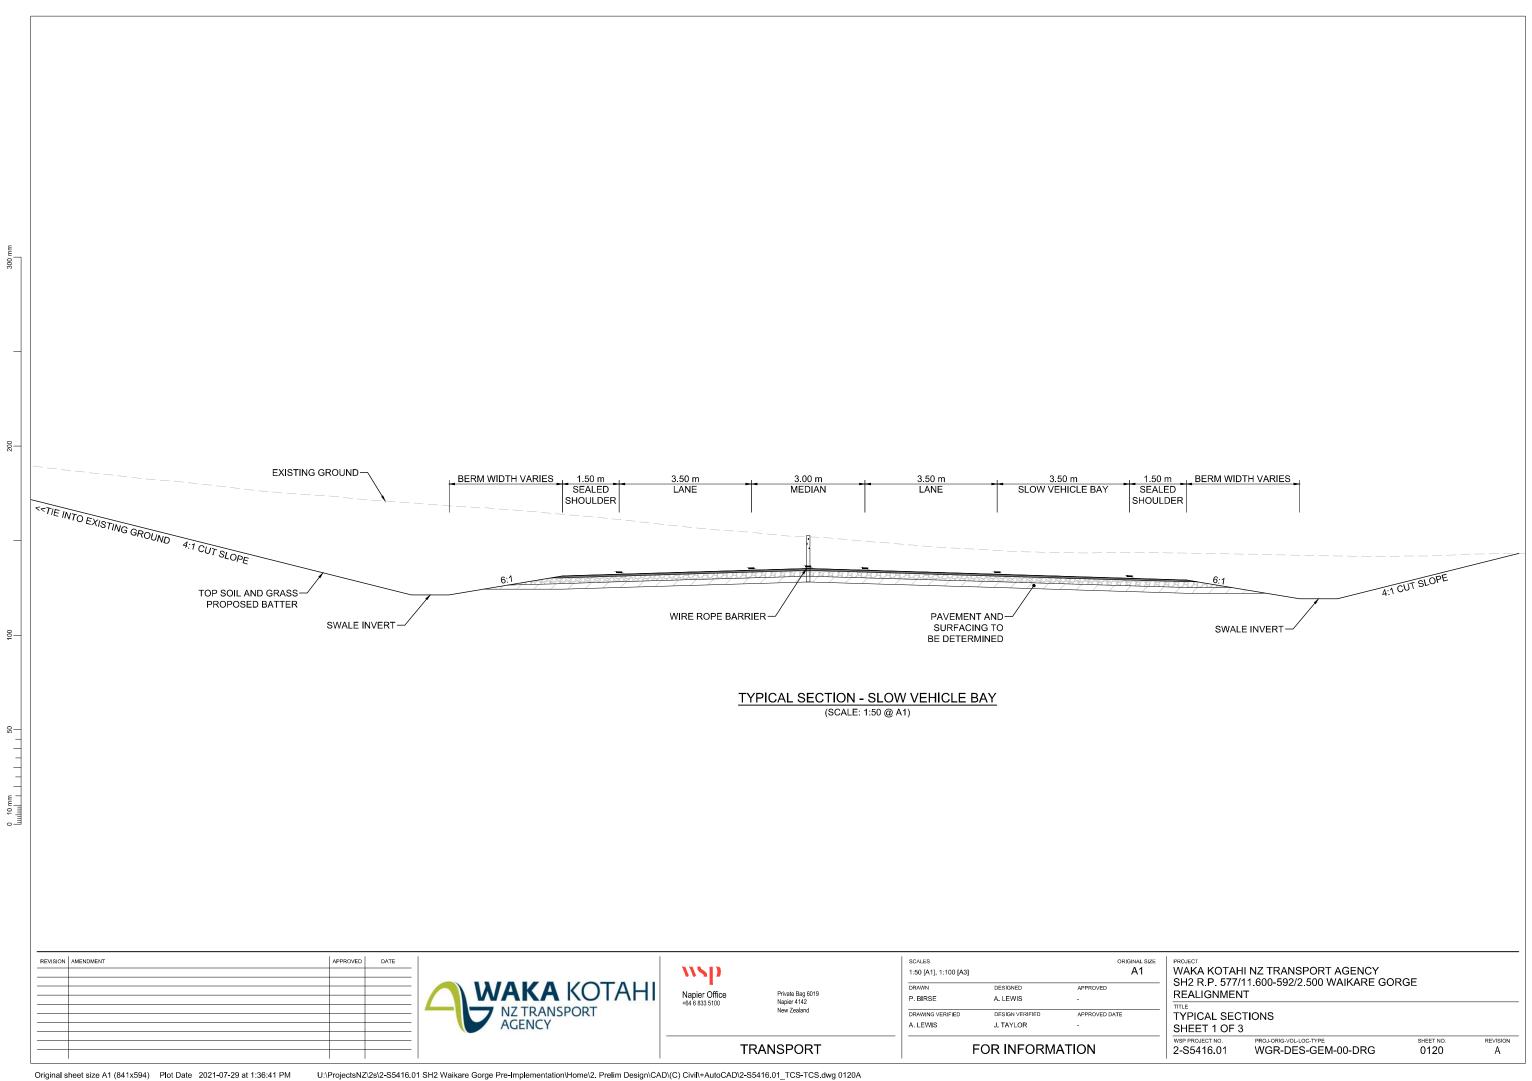

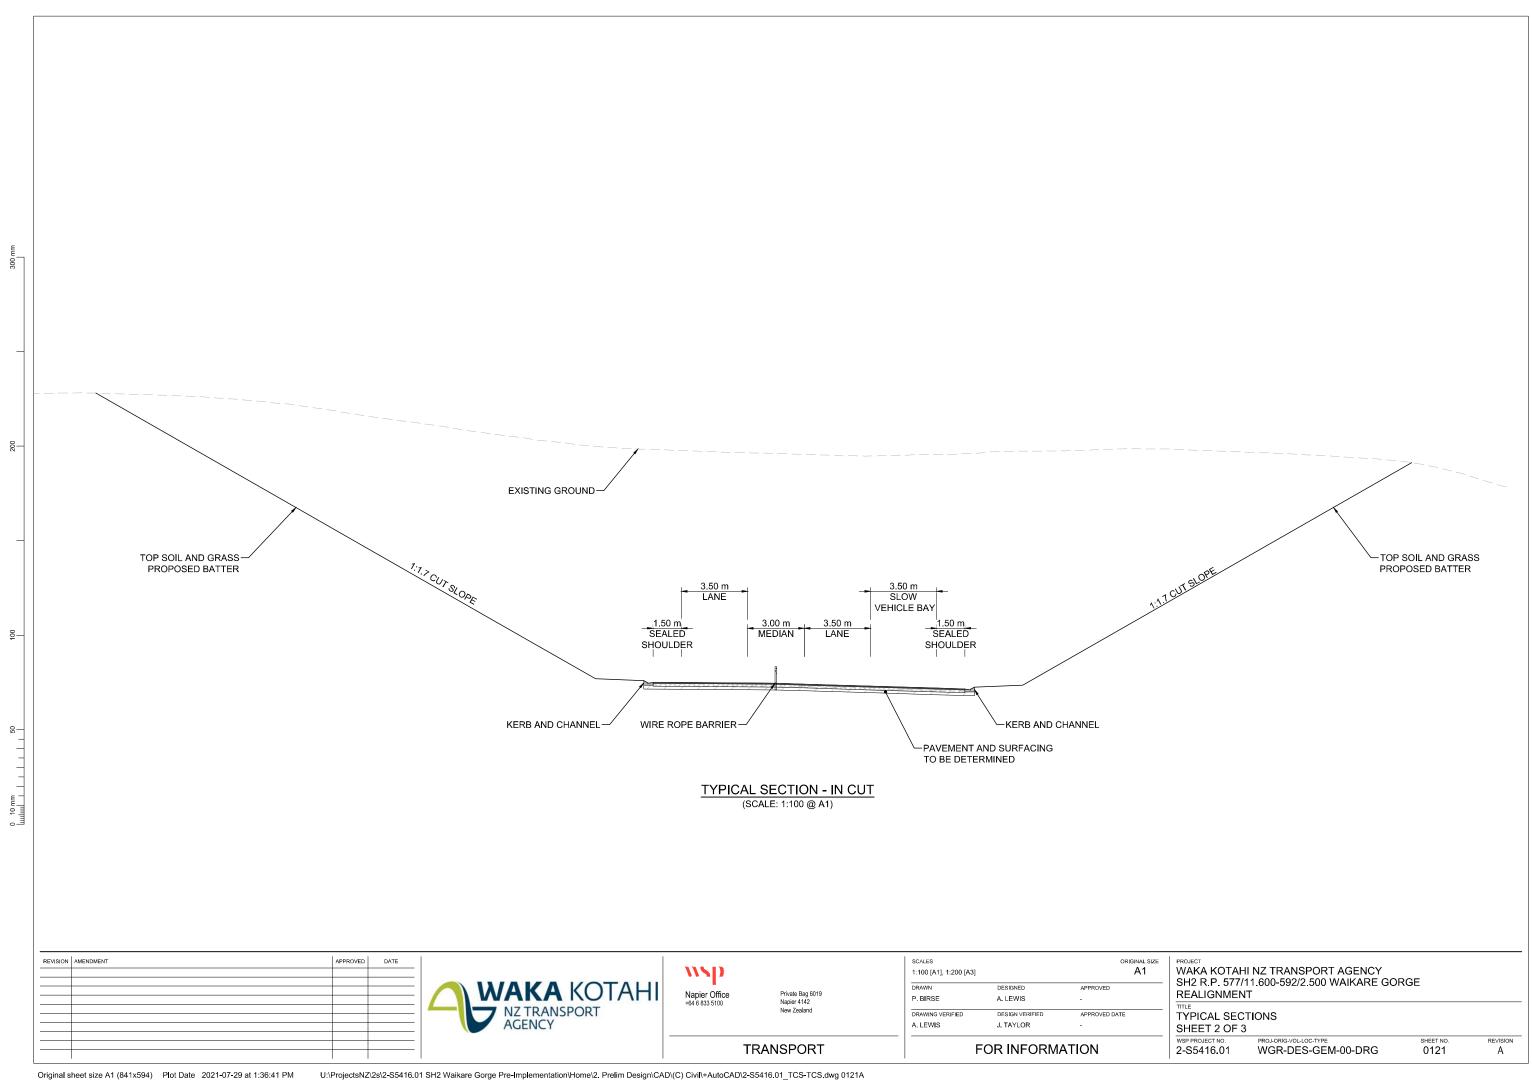

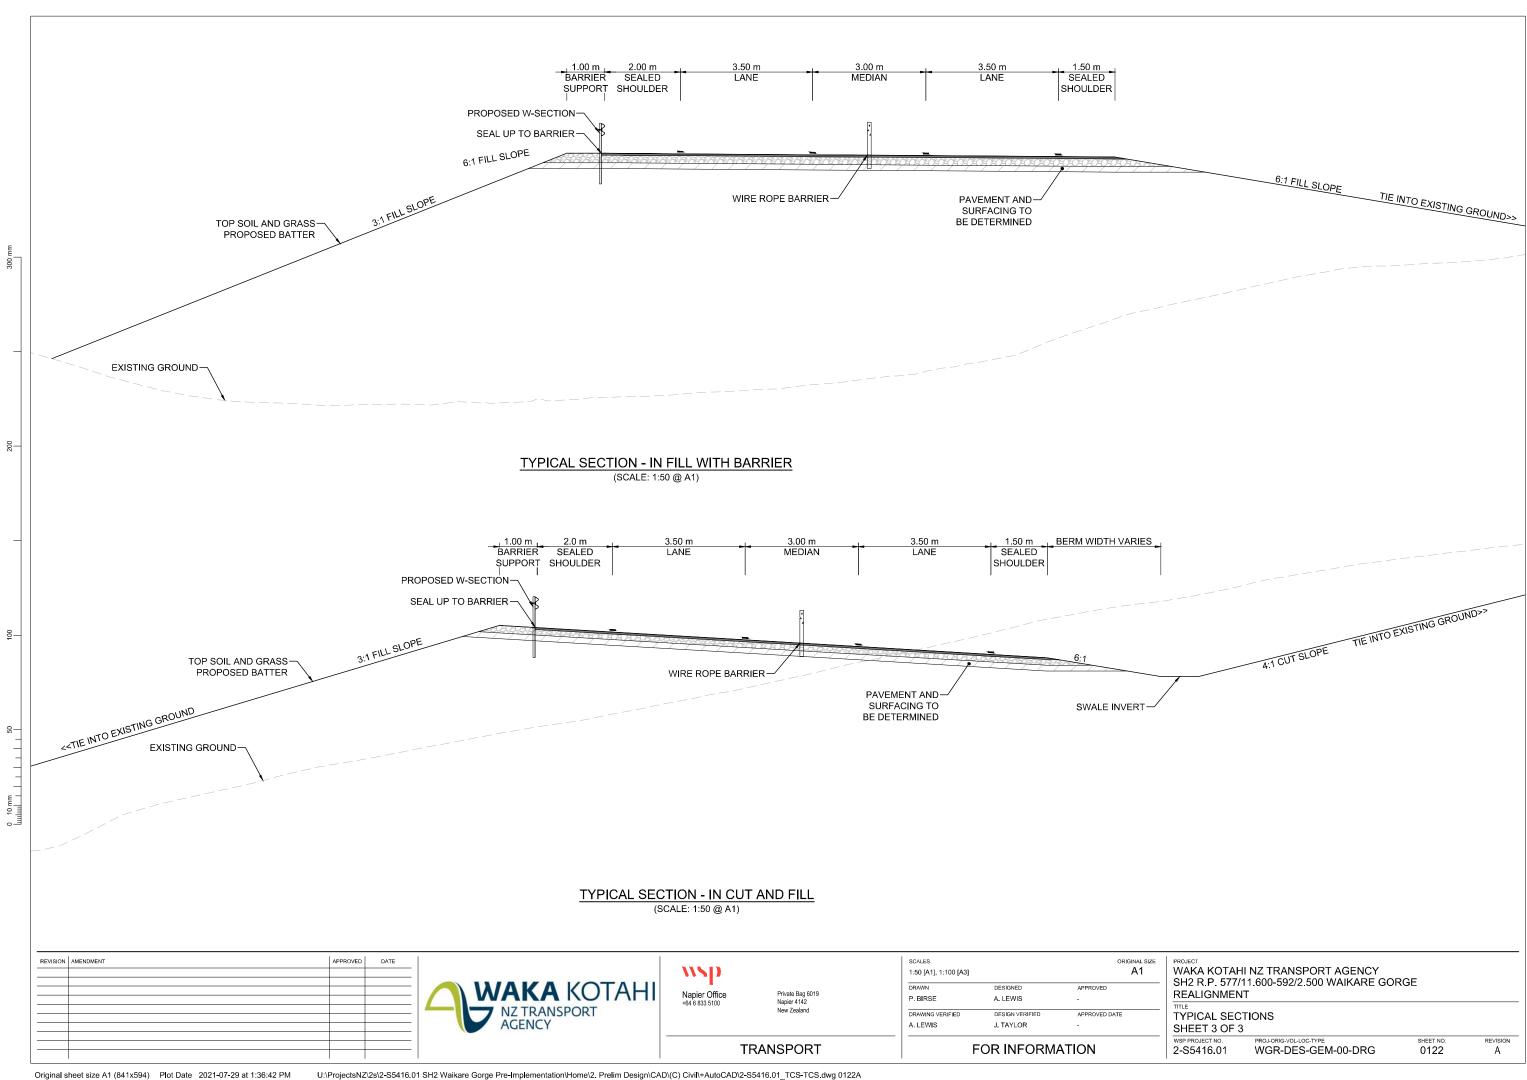

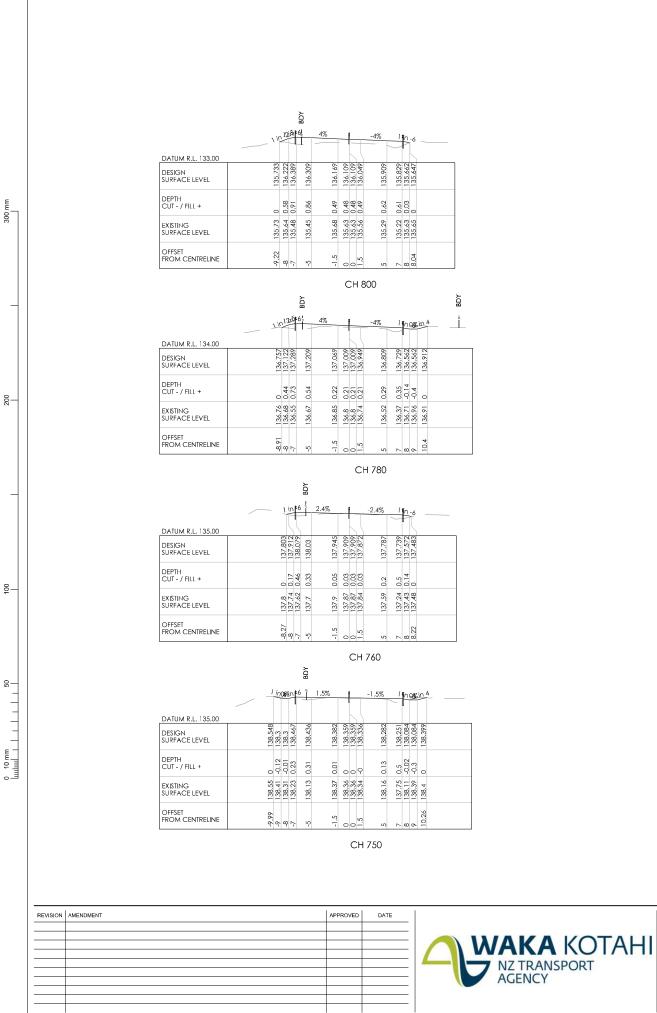

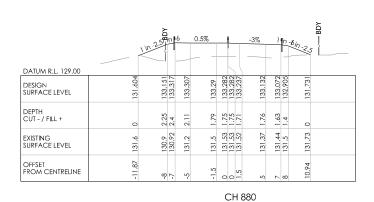

DATUM R.L. 130.00		1 in -2.51	AG 6	2.3%	-	-	-3%	1	n 16n -2.:	
DESIGN SURFACE LEVEL	132.125	133.839	134.006	133.88	133.846	133.801	133.696	133.636	133.469	
DEPTH CUT - / FILL +	0	1.98	2.24		1.39	1.37	1.42	1.74	E. 0	
EXISTING SURFACE LEVEL	132.12	131.86	3 3	132.43	132.45		132.28	131.9	132.17	
OFFSET FROM CENTRELINE	-12.29	ထု	۲	5.1-	00	5	5	7	10.46	

					(	CH	18	50				
			BDY									BDY
	_+ jr	121	4	4%	F	1		-4%		6	F6.2.5	
DATUM R.L. 131.00												
DESIGN SURFACE LEVEL	134.21	134.618	134.705		134.303	134.505	134,445	134.305	134.225	134.058	133.685	
DEPTH CUT - / FILL +	0	0.59	40. 4		2 .	9 6	1.07	1.12	4.	0.83	0	
EXISTING SURFACE LEVEL	134.21	134.03	133.74		100.45	133.43	133.38	133.19	132.82	133.23	133.68	
OFFSET FROM CENTRELINE	-9.02	1 00	, <b>u</b>	,	ر. د	000	1.5	Ŋ	7	00	8.93	

					CH.	840		
			BDY					
		in 215ir	61	4%	+	-4%	7 %	2-6
DATUM R.L. 132.00								\
DESIGN SURFACE LEVEL	134.307	135.373	135.459	135.319	135.259 135.259 135.199	135.059	134.979	134.507
DEPTH CUT - / FILL +	0	1.06	1.02	0.78	0.76 0.76 0.75	0.84	1.17	800
EXISTING SURFACE LEVEL	134.31	134.32	134.27	134.54	134.5 134.5 134.45	134.22	133.81	134.51
OFFSET FROM CENTRELINE	-10.66	1 φ	, ç	-1.5	0 0 1.5	co.	L 0	8.76

**TRANSPORT** 


Napier Office +64 6 833 5100		SCALES 1:250 [A1], 1:500 [A3]		original size
	Private Bag 6019 Napier 4142	DRAWN P. BIRSE	DESIGNED A. LEWIS	APPROVED -
	New Zealand	DRAWING VERIFIED A. LEWIS	DESIGN VERIFIED  J. TAYLOR	APPROVED DATE


FOR INFORMATION


CH 820


	HI NZ TRANSPORT AGENCY /11.600-592/2.500 WAIKARE GO NT	RGE	
TITLE			
CROSS SEC	TIONS		
SHEETS 1 TO	0 43		
WSP PROJECT NO. 2-S5416.01	PROJ-ORIG-VOL-LOC-TYPE WGR-DFS-GFM-00-DRG	SHEET NO. 0150	REVISION A
Z 304 ID U I	VVはR-DES-GEIVI-UU-DRG	นาอบ	A

PROJECT

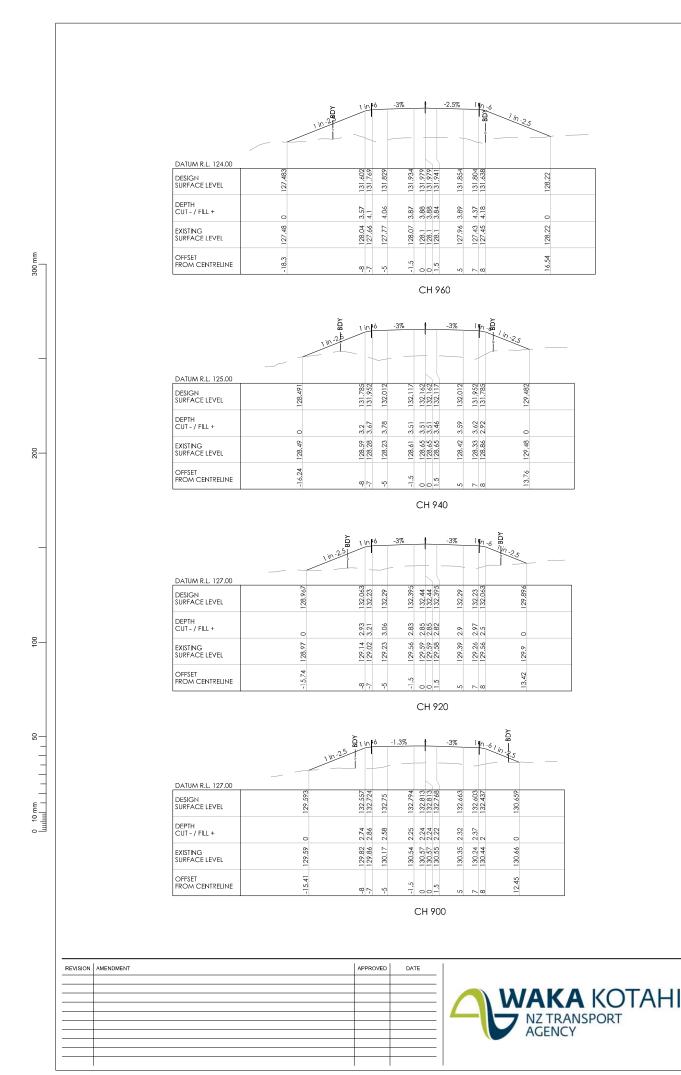

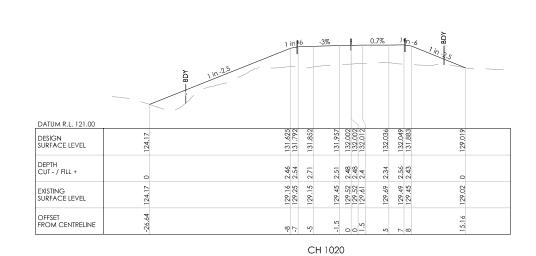

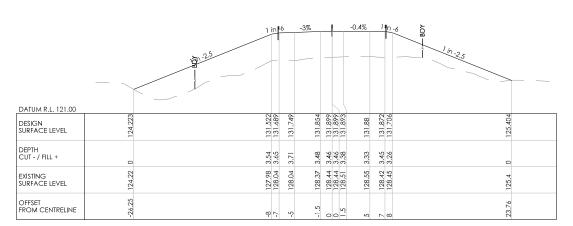

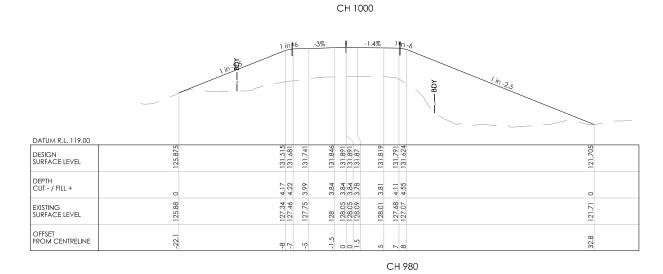


	SCALES 1:250 [A1], 1:500 [A3]					
Private Bag 6019 Napier 4142 New Zealand	DRAWN P. BIRSE	DESIGNED A. LEWIS	APPROVED -			
	DRAWING VERIFIED A. LEWIS	DESIGN VERIFIED  J. TAYLOR	APPROVED DATE			
TRANSPORT		FOR INFORMA	ATION			

	HI NZ TRANSPORT AGENCY /11.600-592/2.500 WAIKARE GOI NT	RGE	
CROSS SECT			
WSP PROJECT NO. 2-S5416.01	PROJ-ORIG-VOL-LOC-TYPE WGR-DES-GEM-00-DRG	SHEET NO. 0151	REVISION A


wsp

Napier Office +64 6 833 5100

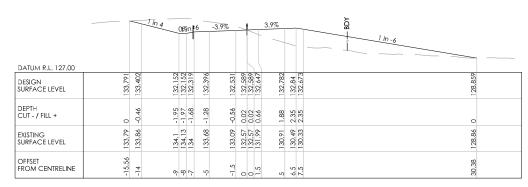

		08an	6	-3%	-	2.8%		lin-6
DATUM R.L. 126.00								
DESIGN SURFACE LEVEL	132.072	132.012	132.239	132.344	132.389	132.529	132.571	132.404
DEPTH CUT - / FILL +	0	0.07	-0.08	-0.16	0.18	1.16	1.95	0 0
EXISTING SURFACE LEVEL	132.07	132.08	132.32	132.51	132.57	131.37	130.63	130.33
OFFSET FROM CENTRELINE	-9.24	م ه ۱	. 2	-1.5	00,		6.5	32.21

CH 1060

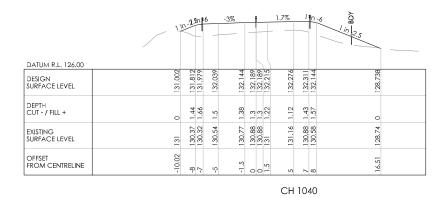

		Tin 4			4.5%	ВОУ	
			01%n 6	-4.5%	4.570	1 in -6	
DATUM R.L. 127.00							
DESIGN SURFACE LEVEL	135.569	133.557	132.307 132.307 132.474 132.564	132.721 132.789 132.789 132.856	133.014 133.081 132.915		129.509
DEPTH CUT - / FILL +	0	-0.95	-0.61 -0.49 -0.06 0.36	1.2	2.46		0
EXISTING SURFACE LEVEL	135.57	134.51	132.91 132.8 132.54	131.52 130.98 130.98 130.8	130.56 130.36 130.33		129.51
OFFSET FROM CENTRELINE	-22.05	4-	5 -7 8 9	-1.5 0 0 1.5	5 7.5		27.93
					CH 1100		

REVISION	AMENDMENT	APPROVED	DATE




Napier Office +64 6 833 5100

Private Bag 6019 Napier 4142 New Zealand

SCALES 1:250 [A1], 1:500 [A3]		ORIGINAL SIZI A1
DRAWN	DESIGNED	APPROVED
P. BIRSE	A. LEWIS	-
DRAWING VERIFIED	DESIGN VERIFIED	APPROVED DATE
A. LEWIS	J. TAYLOR	€

ORIGINAL SIZE A1	PROJECT WAKA KOTAHI NZ TRANSPORT AGENCY SH2 R.P. 577/11.600-592/2.500 WAIKARE GORGE REALIGNMENT
DATE	TITLE
JAIL	L CROSS SECTIONS

ı	REALIGINIVIE	N I									
ı	TITLE										
CROSS SECTIONS											
ı	SHEETS 1 TO 43										
ı	SHEETSTIC	743									
ı	WSP PROJECT NO.	PROJ-ORIG-VOL-LOC-TYPE	SHEET NO.	REVISION							
ı	2-S5416.01	WGR-DES-GEM-00-DRG	0152	Α							
ı											

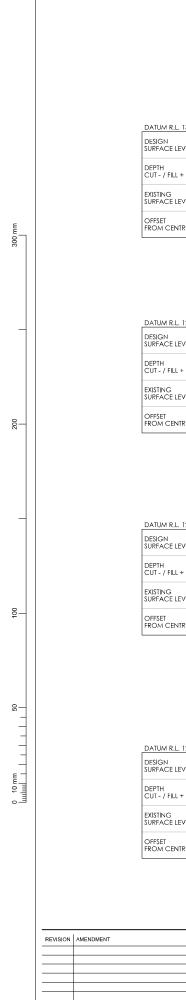


	1 jr	-2.5	in F	6	-4.5%	_		+	4.5%		1	in -6	
DATUM R.L. 130.00													
DESIGN URFACE LEVEL	132.144	132.907	133.074	133.164	133.321	133,389	133.389	133.456	133.614	133.681	133.515	133.079	
DEPTH CUT - / FILL +	0	69.0	0.83	16.0	0.94	96.0	96.0	_	0.93	0.94	0.7	0	
XISTING URFACE LEVEL	132.14	132.22	132,25	132.26	132.38	132.43	132.43	132.46	132.68	132.74	132.82	133.08	
OFFSET ROM CENTRELINE	-9.91	ထု	-7	5	<u>.</u> 2.	0	0	1.5	ιΩ	6.5	7.5	10.11	


CH 1180

		1 in -2.51 in 16	-4.5%		-	4.5%	_		1 in -6
DATUM R.L. 129.00									
DESIGN SURFACE LEVEL	131.319	132.82	8 8	133 302	133.302	133.527	- 8	133.428	130.992
DEPTH CUT - / FILL +	0	1.55	1.87	23.19	2.31	2.64	2.76	2.58	0
EXISTING SURFACE LEVEL	131.32	131.27		130.99	130.99	130.89	130.84	130.84	130.99
OFFSET FROM CENTRELINE	-11.75	-7		- c	0 -		6.5	7.5	22.11


CH 1160

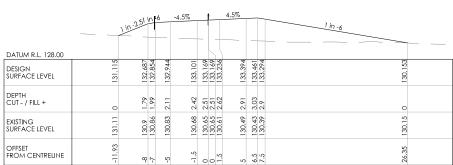

CH 1140

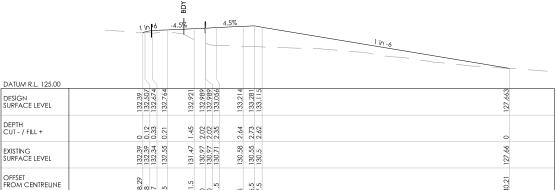

CH 1120

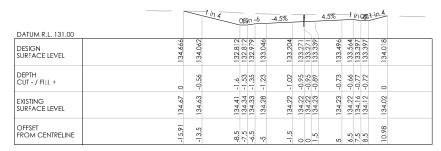

CH 1260

	_		1 in 4 0%	in -6	-4.5%		4.5%	1 ir	10%	1 in 4
DATUM R.L. 131.00										
DESIGN SURFACE LEVEL	134.958	134.161	132.911	133.078	133.146	133.371 133.371 133.438	133.596	133.663	133.496	134.512
DEPTH CUT - / FILL +	0	-0.74	-2.04	1.89	-1.6	-1.53	-1.2		-1.17	0
EXISTING SURFACE LEVEL	134.96	134.9	134.95	134.97	134.97	134.9 134.9 134.85	134.79	134.76	134.67	134.51
OFFSET FROM CENTRELINE	-16.69	-13.5	-8.5 -7.5	-6.5	-5. -1.5	0 0 -	r)	6.5	8.5	12.56

CH 1240

		BDY												
		!		)(%)n	-6	-4.5%	- 	_	4.5%	1 ir	08%	1 ir	14	
DATUM R.L. 131.00		4		_	- 00									
DESIGN SURFACE LEVEL	136.642	134.21	132.964	132.964	133.198	133.356	133.423	133.423	133.648	133.716	133.549	134.799	136.016	
DEPTH CUT - / FILL +	0	-2.7	1.4-	-4.1	-3.95	-3.92	-3.81	-3.81	3.43	-3.21	-3.2	-1.6		
EXISTING SURFACE LEVEL	136.64	136.92	137.06	137.06	137.14	137.27	137.23	137.23	137.08	136.92	136.75	136.4	136.02	
OFFSET FROM CENTRELINE	-23.21	-13.5	-8.5	-7.5	-5	-1.5	0	0	2	6.5	8.5	13.5	18.37	

CH 1220

	— "— BDY	lin 4	0%an \$6	4.5% 4.5%	1 in 0%	1104
DATUM R.L. 131.00  DESIGN SURFACE LEVEL	135.243	134.198	132.948 132.948 133.114 133.204	133.362 133.429 133.497 133.654	133.722	137
DEPTH CUT - / FILL +	0	-1.49	-3.42 -3.47 -3.43	3.65 3.65 3.65 3.65		0
EXISTING SURFACE LEVEL	135.24	135.69	136.36 136.42 136.55 136.71	136.99 137.08 137.15 137.15		137
OFFSET FROM CENTRELINE	-18.18	-14	6 8 7 9	-1.5 0 0 1.5	6.5 7.5 8.5 8.5	22.28

CH 1200

REVISION	AMENDMENT	APPROVED	DATE






Private Bag 6019 Napier 4142 New Zealand

SCALES 1:250 [A1], 1:500 [A3]		ORIGINAL SIZE A1	PROJ WA
DRAWN	DESIGNED	APPROVED	SH
P. BIRSE	A. LEWIS	-	RE
DRAWING VERIFIED	DESIGN VERIFIED	APPROVED DATE	CR
A. LEWIS	J. TAYLOR	=	SH

_	WAKA KOTAHI NZ TRANSPORT AGENCY SH2 R.P. 577/11.600-592/2.500 WAIKARE GORGE REALIGNMENT
_	TITLE

П	CROSS SECTI SHEETS 1 TO		
	WSP PROJECT NO. 2-S5416.01	PROJ-ORIG-VOL-LOC-TYPE WGR-DES-GEM-00-DRG	SHEET NO. 0153

REVISION A

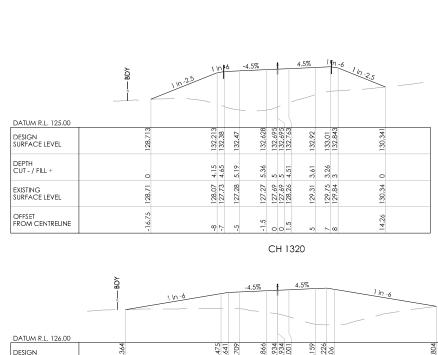

DATUM R.L. 126.00

DESIGN

DESIGN

DESIGN

DEPTH

CUT-/FILL+

DEPTH

C

CH 1300

CH 1280

DATUM R.L. 129.00

DESIGN SURFACE LEVEL

DEPTH CUT -/ FILL +

EXISTING SURFACE LEVEL

OFFSET FROM CENTRELINE

DEPTH CUT -/ FILL +

OFFSET FROM CENTRELINE


OFFSET FROM CENTRELINE

DEPTH CUT -/ FILL +


OFFSET FROM CENTRELINE

	,— BDY	1 in 2.5	6	-4.5%	-		4.5%	1	n -6	1 in .2.5
DATUM R.L. 125.00										
DESIGN SURFACE LEVEL	126.821	131.218	131.475	131.632	131.7	131.767	131.925	132.015	131.848	128.106
DEPTH CUT - / FILL +	0	3.98	4.08	4.17	4.2	4.25	4.26	4.27	4.07	0
EXISTING SURFACE LEVEL	126.82	127.24	127.39	127.46	127.5	127.52	127.66	127.75	127.78	128.11
OFFSET FROM CENTRELINE	-18.99	-8	5-	-1.5	0	1.5	ro.	_	89	17.36

CH 1380

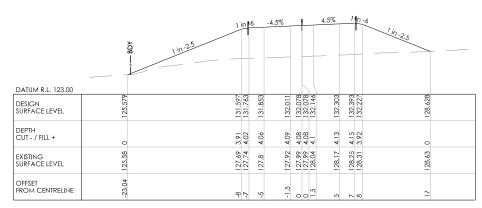

CH 1360

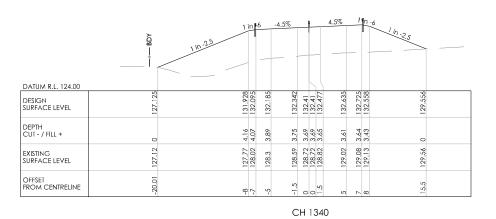

REVISION	AMENDMENT	APPROVED	DATE





Private Bag 6019 Napier 4142 New Zealand

TRANSPORT

SCALES 1:250 [A1], 1:500 [A3]		original size A1
DRAWN	DESIGNED	APPROVED
P. BIRSE	A. LEWIS	=
DRAWING VERIFIED	DESIGN VERIFIED	APPROVED DATE
A. LEWIS	J. TAYLOR	Ē


ı	PROJECT
I	WAKA KOTAHI NZ TRANSPORT AGENCY
I	SH2 R.P. 577/11.600-592/2.500 WAIKARE GORGE
	REALIGNMENT
l	TITLE
l	CROSS SECTIONS
l	SHEETS 1 TO 43
ı	

WGR-DES-GEM-00-DRG

2-S5416.01

REVISION


SHEET NO. 0154

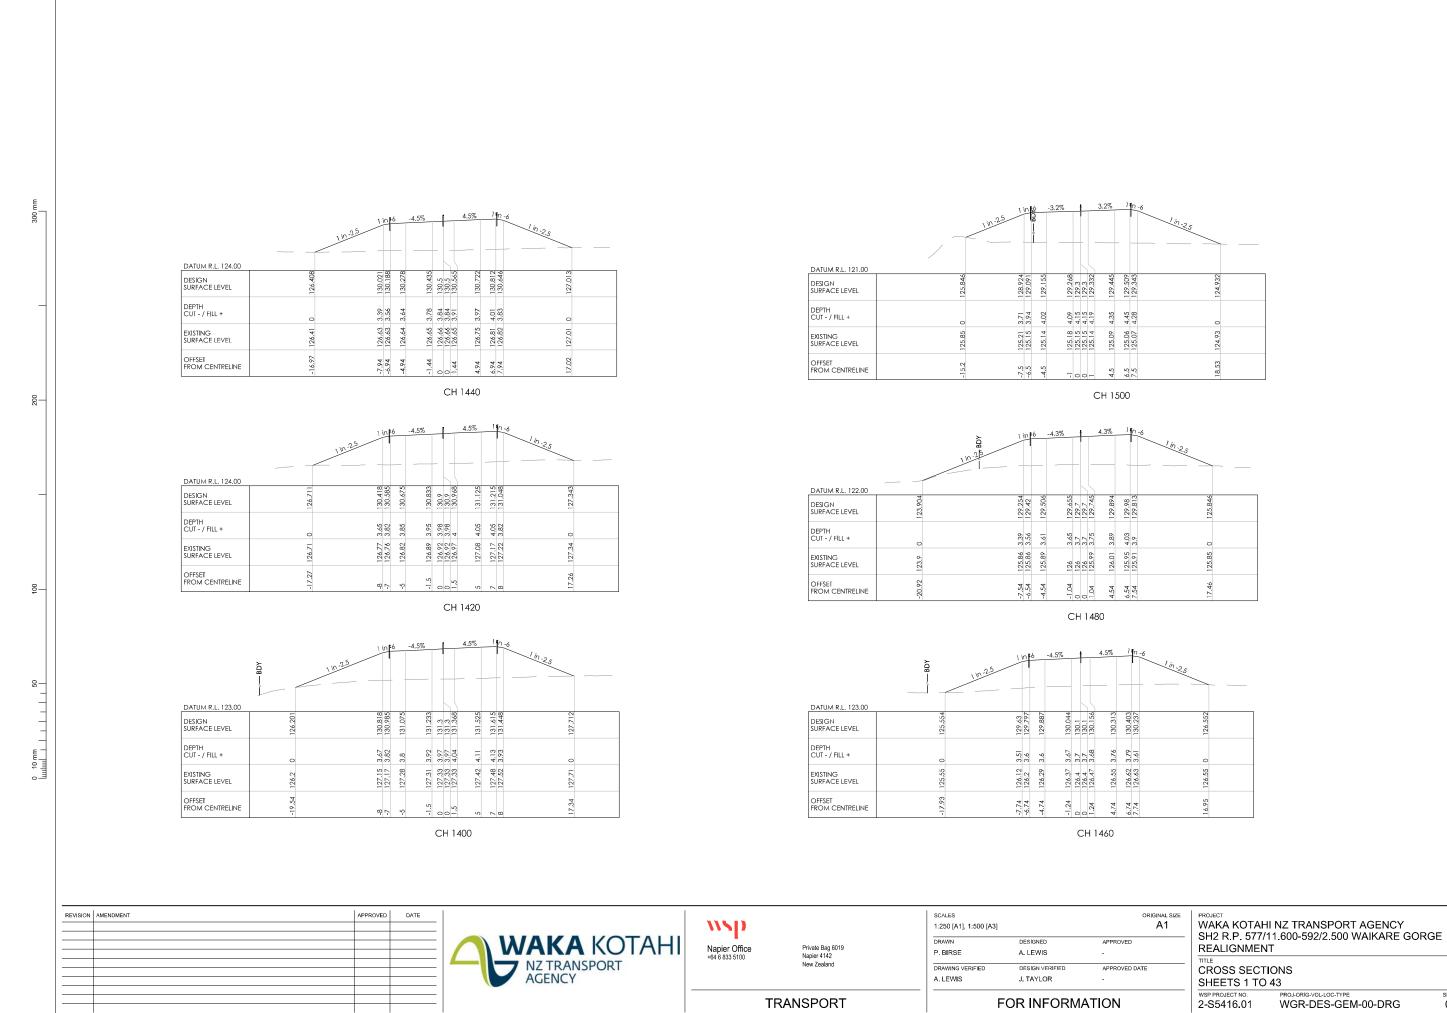


REVISION A

SHEET NO. 0155

WGR-DES-GEM-00-DRG

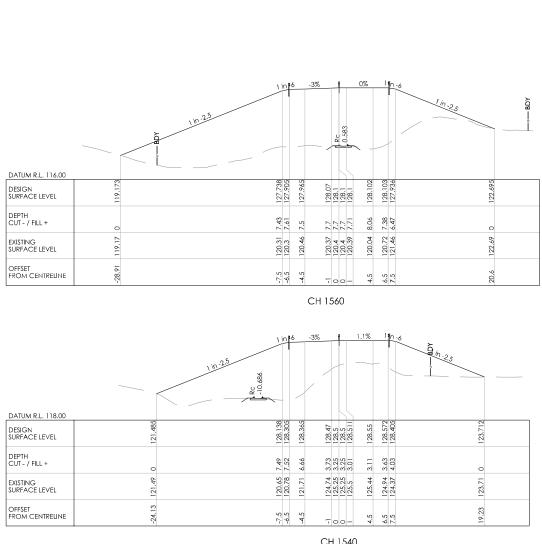

CH	1540

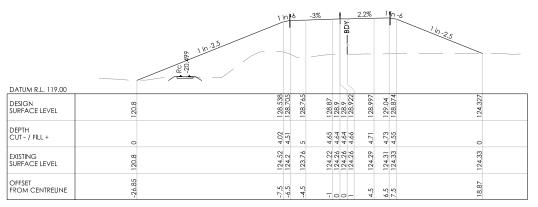

$\cap$ H	1520
CH.	1.520

REVISION	AMENDMENT	APPROVED	DATE

Original sheet size A1 (841x594) Plot Date 2021-07-29 at 1:42:32 PM





Private Bag 6019 Napier 4142 New Zealand

TRANSPORT

ORIGINAL SIZE A1 1:250 [A1], 1:500 [A3] DRAWN P. BIRSE A. LEWIS DRAWING VERIFIED


SCALES

FC	R INFORMAT	ION
LEWIS	J. TAYLOR	=
TOWNING VEIGINED	DEGIGIT VERTILED	AT THOUSED DATE

WAKA KOTAHI NZ TRANSPORT AGENCY SH2 R.P. 577/11.600-592/2.500 WAIKARE GORGE REALIGNMENT


CROSS SECTIONS SHEETS 1 TO 43


SHEET NO. 0156 2-S5416.01 WGR-DES-GEM-00-DRG

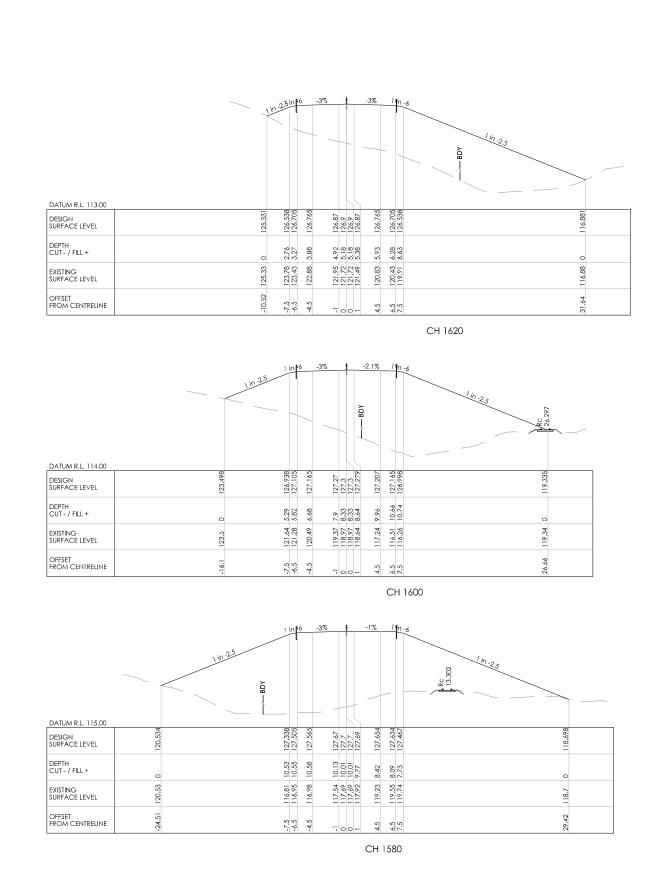

REVISION	AMENDMENT APPR	OVED DATE		wsp		SCALES 1:250 [A1], 1:500 [A3]		ORIGINAL SIZE		HI NZ TRANSPORT AGENCY /11.600-592/2.500 WAIKARE GOF	DRGE
			WAKA KOTAHI NZ TRANSPORT AGENCY	Napier Office +64 6 833 5100	Private Bag 6019 Napier 4142 New Zealand	DRAWN P. BIRSE DRAWING VERIFIED A. LEWIS	DESIGNED A. LEWIS  DESIGN VERIFIED J. TAYLOR	APPROVED - APPROVED DATE -	REALIGNMEN TITLE CROSS SECT SHEETS 1 TO	NT FIONS	
				-	TRANSPORT	F	OR INFORM	ATION	wsp project no. 2-S5416.01	PROJ-ORIG-VOL-LOC-TYPE WGR-DES-GEM-00-DRG	SHEE 01

SHEET NO. 0157

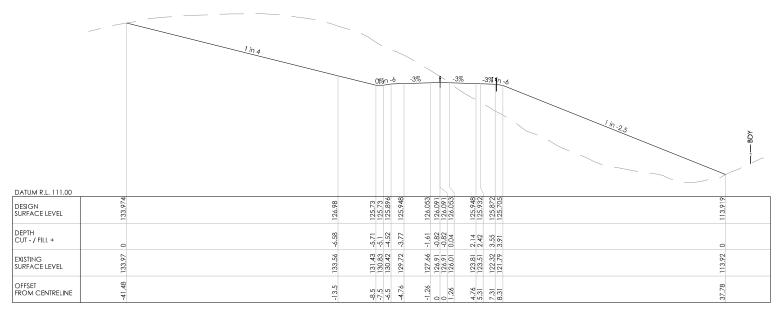

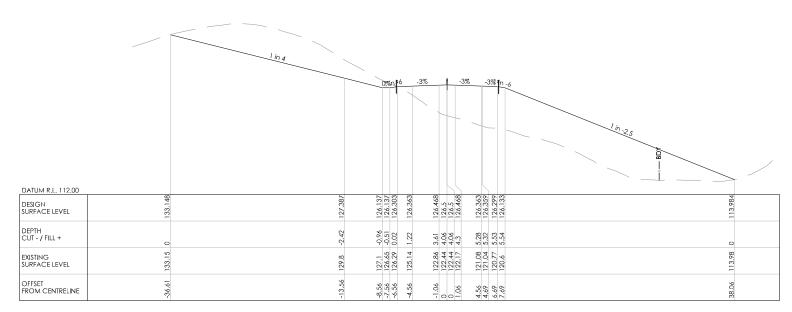

CH 1640

REVISION	AMENDMENT	APPROVED	DATE

Original sheet size A1 (841x594) Plot Date 2021-07-29 at 1:42:55 PM



1110	d)
Napier	r Office
+64 6 83	3 5100

Private Bag 6019 Napier 4142 New Zealand

TRANSPORT

DRAWN	DESIGNED	APPROVED
P. BIRSE	A. LEWIS	_
I DINOL	76. EE 1110	
DRAWING VERIFIED	DESIGN VERIFIED	APPROVED DATE
A. LEWIS	J. TAYLOR	_


FOR INFORMATION


SCALES 1:250 [A1], 1:500 [A3]

ORIGINAL SIZE A1	WAKA KOTAHI NZ TRANSPORT AGENCY SH2 R.P. 577/11.600-592/2.500 WAIKARE GORGE REALIGNMENT
	TITLE


CROSS SECTIONS SHEETS 1 TO 43

SHEET NO. 0158 REVISION A WSP PROJECT NO. 2-S5416.01 WGR-DES-GEM-00-DRG

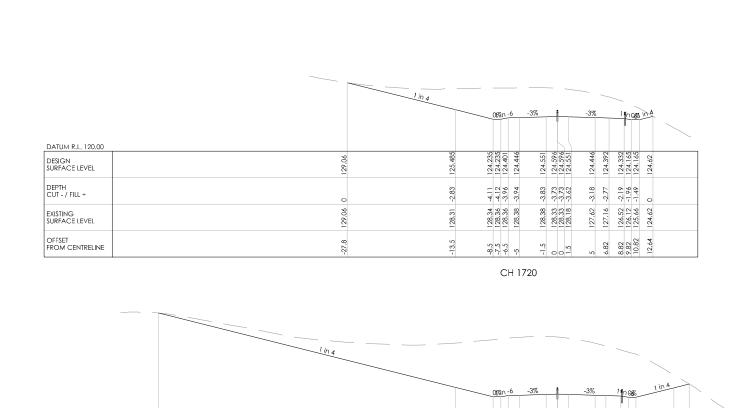

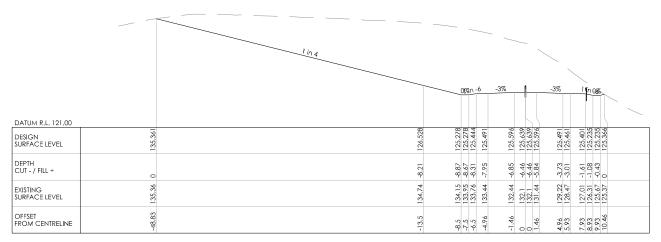

CH 1680

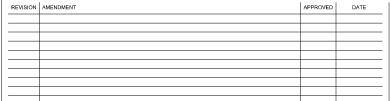





Private Bag 6019 Napier 4142 New Zealand

l	DRAWN	DESIGNED	APPROVED	
	P. BIRSE	A. LEWIS	=	
	DRAWING VERIFIED	DESIGN VERIFIED	APPROVED DATE	_
	A. LEWIS	J. TAYLOR	-	
ı				

FOR INFORMATION

SCALES 1:250 [A1], 1:500 [A3]

_	F
	TI
APPROVED DATE	C
-	S

WAKA KOTAHI NZ TRANSPORT AGENCY SH2 R.P. 577/11.600-592/2.500 WAIKARE GORGE REALIGNMENT

SHEET NO. 0159

REVISION

CROSS SECTIONS SHEETS 1 TO 43


2-S5416.01 WGR-DES-GEM-00-DRG


TRANSPORT

DATUM R.L. 121.00 DESIGN SURFACE LEVEL

DEPTH CUT - / FILL + EXISTING SURFACE LEVEL

OFFSET FROM CENTRELINE

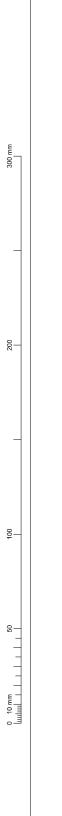

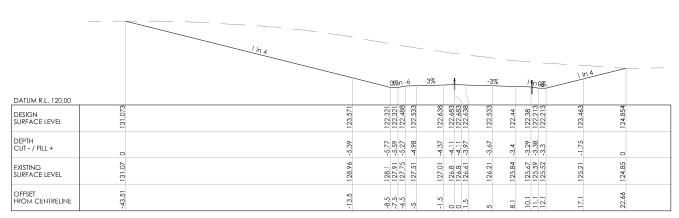

	1 in 4							<b>—</b>
DATUM R.L. 121.00			08an -6 -3	3%	-3%	1 \$n 9%	1 in 4	
DESIGN SURFACE LEVEL	127.47	124.255	123.005 123.005 123.172 123.217	123.322 123.367 123.367 123.322	α.	123.137 123.077 122.91 122.91	-	125.157
DEPTH CUT - / FILL +	0	-2.73	-3.54 -3.45 -3.2 -2.99	-2.59 -2.42 -2.42 -2.31		-2.22 -2.27 -2.42 -2.41	-1.17	0
EXISTING SURFACE LEVEL	127.47	126.99	126.54 126.45 126.37 126.21	125.91 125.78 125.78 125.64	25.	125.36 125.34 125.33 125.32	125.33	125.16
OFFSET FROM CENTRELINE	-26.36	-13.5	-8.5 -7.5 -6.5	-1.5 0 0 1.5		7.67 9.67 10.67 11.67	16.67	20.66

CH 1760

	1 in 4 086n - 6 - 3% - 3% 14n - 6 1/n - 25
DATUM R.L. 118.00	
DESIGN SURFACE LEVEL	124.417 123.643 123.643 123.85 123.85 124.000 124.000 123.78 123.78 123.78 123.56 123.56 123.56
DEPTH CUT - / FILL +	0 0 0 0 0 0 0 0 0 0 0 0 0 0 0 0 0 0 0
EXISTING SURFACE LEVEL	124,42 123,64 123,54 123,58 122,58 122,42 122,13 122,13 122,13
OFFSET FROM CENTREUNE	11.6 8.5 7.5 6.5 6.5 6.5 6.5 7.2 5 5 5 5 5 7.25 10.25 10.25

CH 1740

REVISION	AMENDMENT	APPROVED	DATE



wsp Napier Office +64 6 833 5100

Private Bag 6019 Napier 4142 New Zealand


TRANSPORT

SCALES 1:250 [A1], 1:500 [A3] ORIGINAL SIZE P. BIRSE A. LEWIS DRAWING VERIFIED A. LEWIS J. TAYLOR

WAKA KOTAHI NZ TRANSPORT AGENCY SH2 R.P. 577/11.600-592/2.500 WAIKARE GORGE REALIGNMENT CROSS SECTIONS SHEETS 1 TO 43

FOR INFORMATION

SHEET NO. 0160 REVISION 2-S5416.01 WGR-DES-GEM-00-DRG

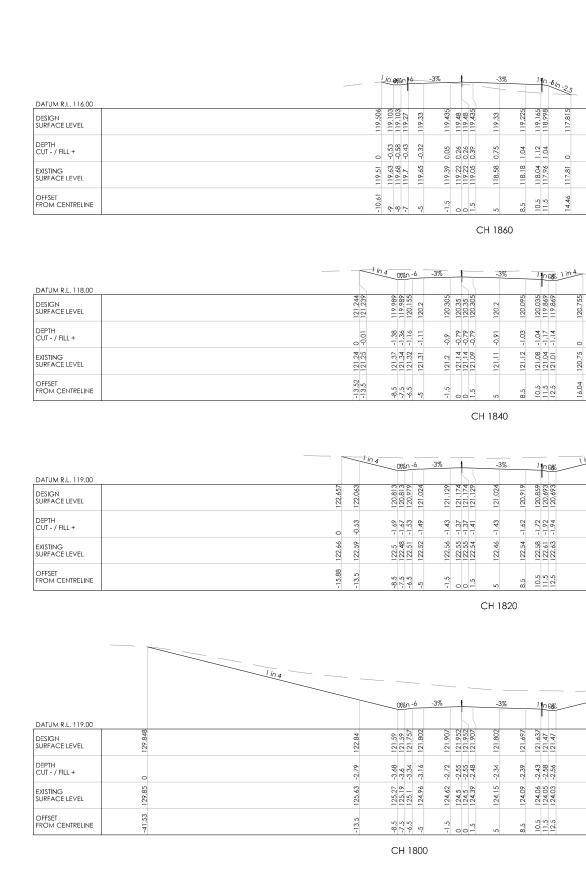

		lin 4 Offen	6 -1	.7%	-	-3%		15	n 98%	
DATUM R.L. 115.00								ľ		
DESIGN SURFACE LEVEL	118.406	117.317 117.317 117.483	117.516		117.6	117.45	117.345		117.118	
DEPTH CUT - / FILL +	0	-0.63 -0.53 -0.26	-0.06	0.11	0.24	0.2	0.05	0	0.02	
EXISTING SURFACE LEVEL	118.41	117.95 117.84 117.75	117.58		117.36	117.25	117.29		117.32	
OFFSET FROM CENTRELINE	-13.36	487	5	-1.5	0.1.5	SO.	8.5	10.5	12.5 13.37	

CH 1880

		1 in 2.51 in 16	-3%	-3%	1 <b>f</b> n +6in -2.5	
DATUM R.L. 114.00						
DESIGN SURFACE LEVEL	116.602	മെ	118.413 118.518 118.563 118.563	118.413	118.248	
DEPTH CUT - / FILL +	0	1.51	1.68	1.43	0.99	
EXISTING SURFACE LEVEL	116.6	116.67	116.73 116.84 116.84 116.84	116.99	117.08	
OFFSET FROM CENTRELINE	-11.96	-8	-5 -1.5 0 0 1.5	ro «		

ORIGINAL SIZE

REVISION	AMENDMENT	APPROVED	DATE

Original sheet size A1 (841x594) Plot Date 2021-07-29 at 1:43:29 PM



11/5	)
Napier C +64 6 833 5	ffice 100


Private Bag 6019 Napier 4142 New Zealand

TRANSPORT

	original s A1
DESIGNED	APPROVED
A. LEWIS	-
DESIGN VERIFIED	APPROVED DATE
J. TAYLOR	-
	A. LEWIS  DESIGN VERIFIED


PROJECT
WAKA KOTAHI NZ TRANSPORT AGENCY
SH2 R.P. 577/11.600-592/2.500 WAIKARE GORGE
REALIGNMENT
TITLE


	REALIGINIVE	N I		
	TITLE			
	CROSS SECT	TIONS		
	SHEETS 1 TO	143		
_	WSP PROJECT NO.	PROJ-ORIG-VOL-LOC-TYPE	SHEET NO.	REVISION
	2-S5416.01	WGR-DES-GEM-00-DRG	0161	Α

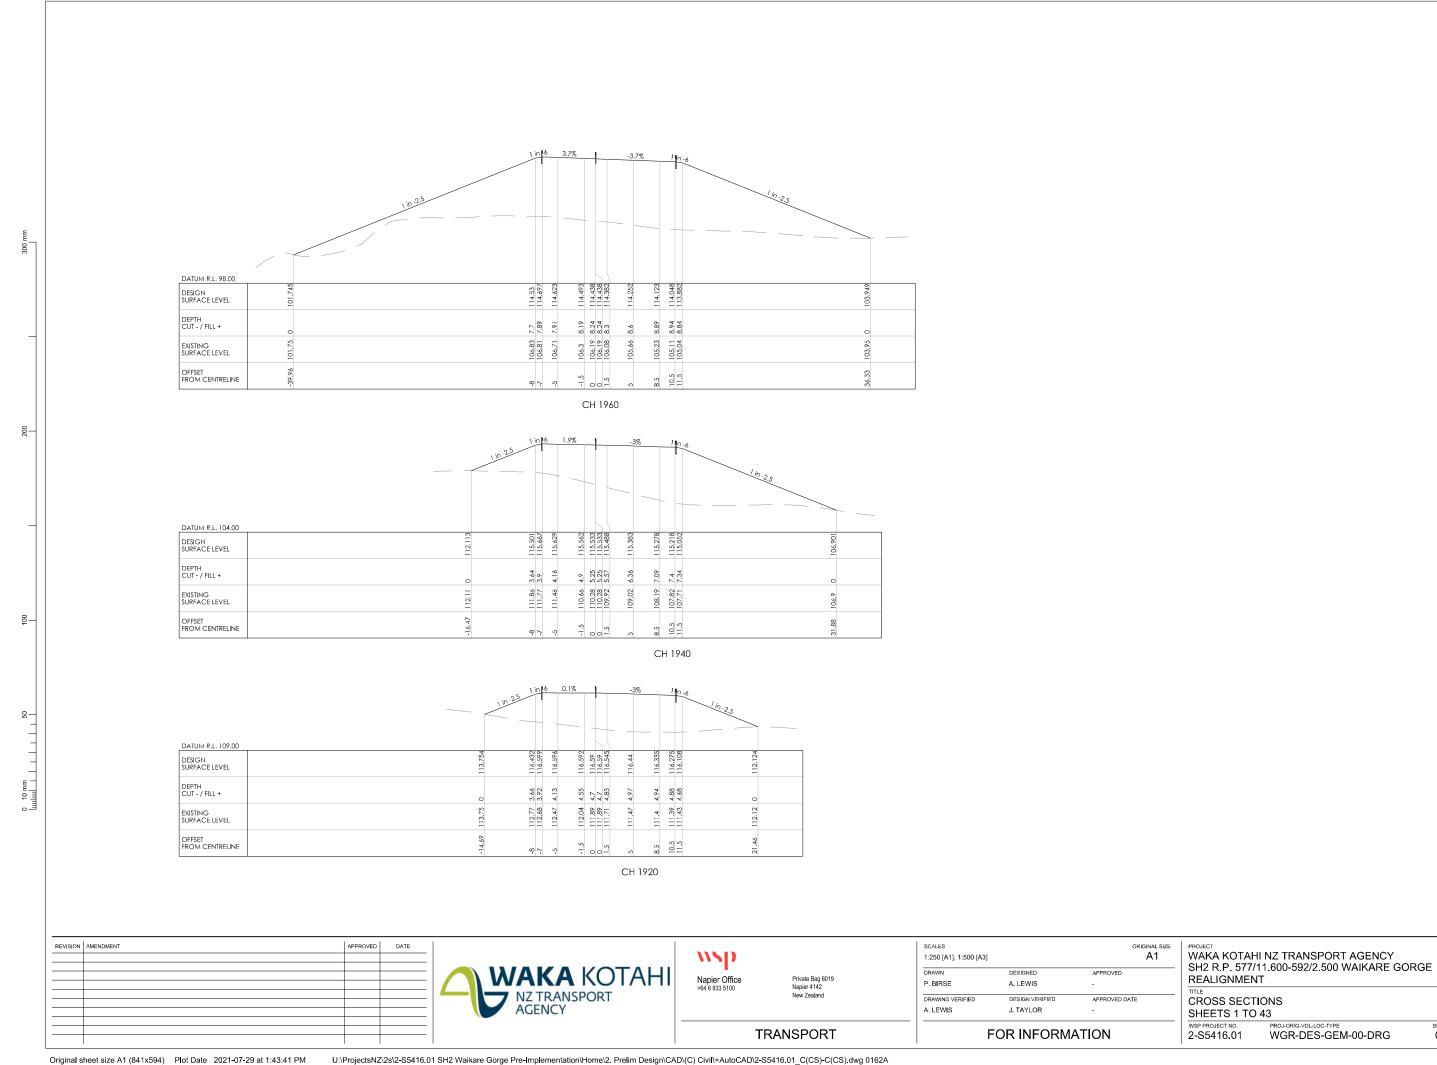



SHEET NO. 0162

WGR-DES-GEM-00-DRG

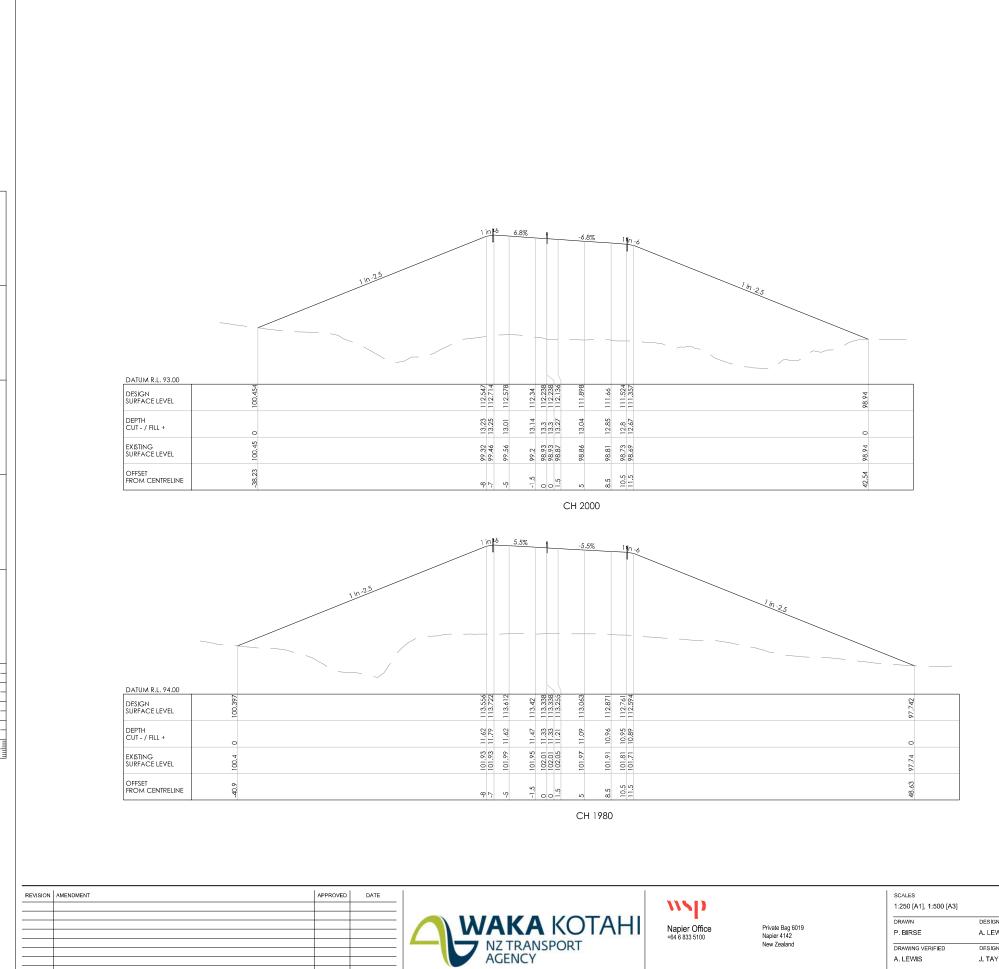

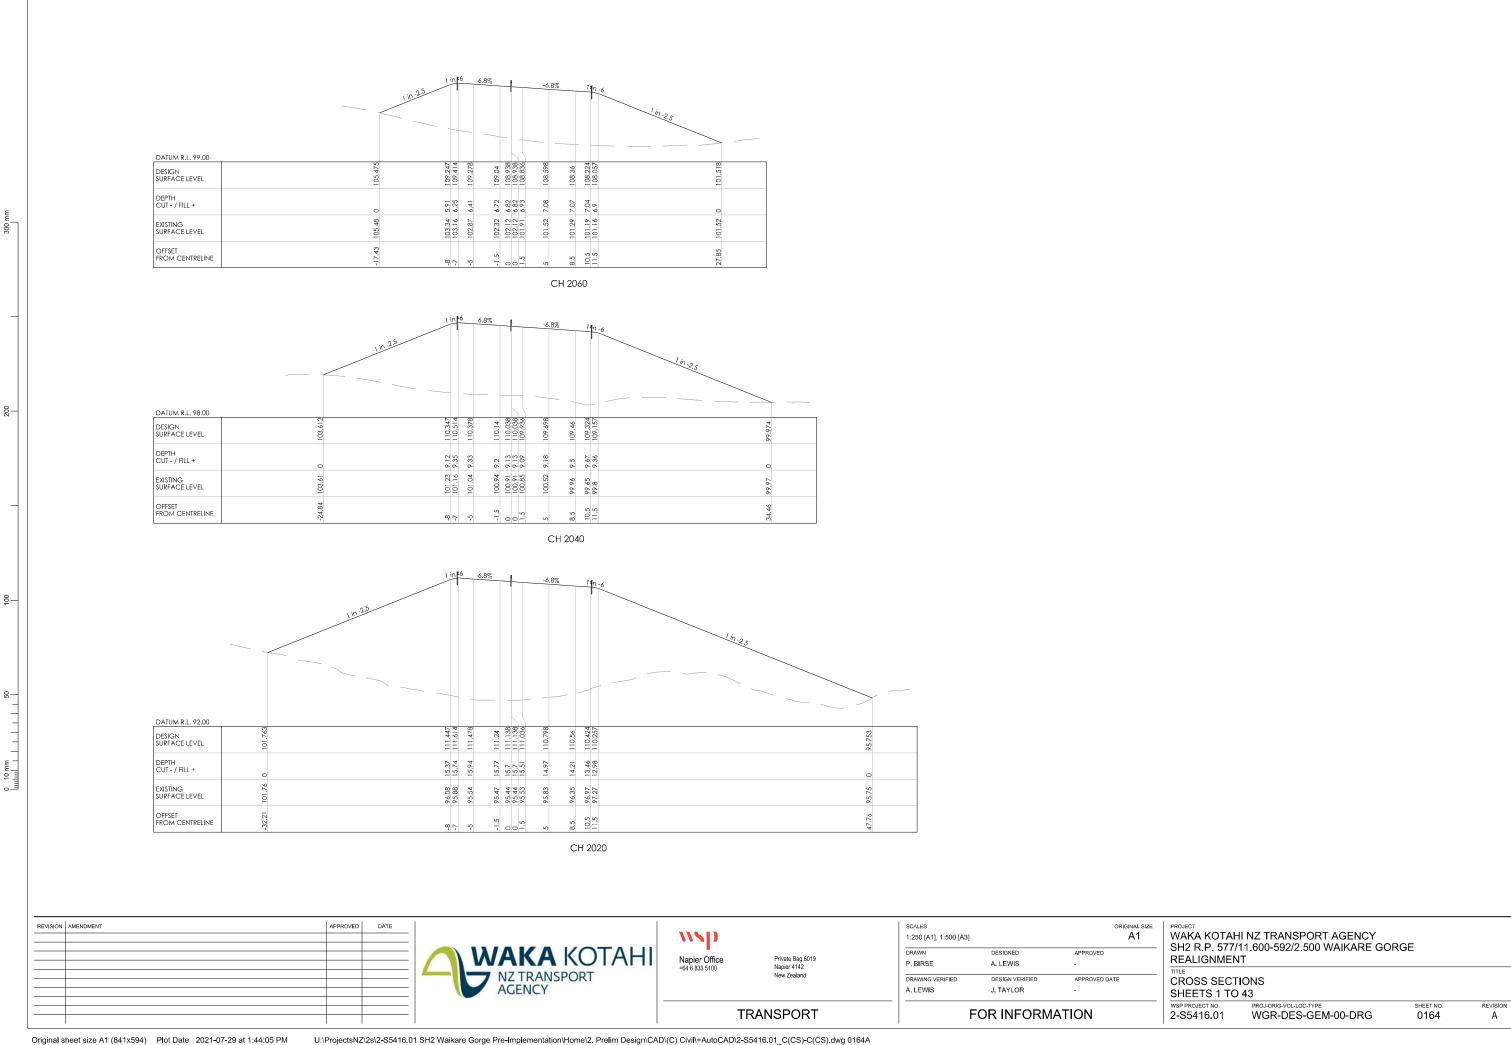

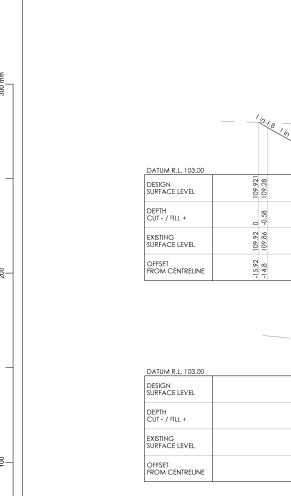

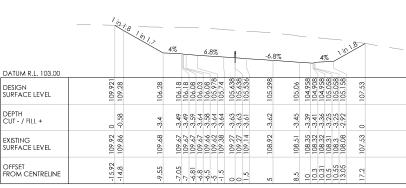

		4%	T	_	6.8	3%	_	+	_	-6.8%			4	%	_1 ir	1-6	
DATUM R.L. 103.00			4			-			\			- [	4		7		
DESIGN SURFACE LEVEL	107.878	107.28	107.28	107.13	107.18	107.078	107.730	106.738	<b>1</b> 0	106.398	106.16	106.058	106.058	106.158	106.258	105.612	
DEPTH CUT - / FILL +	0-0.48	-0.5	0.5	-0.65	-0.59	0.58	9	-0.49	-0.45	-0.32	-0.17	-0.1	-0.12	0.05	0.0	0	
EXISTING SURFACE LEVEL	107.88	107.78	107.78	107.78	107.76	107.66	107.00	107.23	107.08	106.72	106.33		106.13		105.86	105.61	
OFFSET FROM CENTRELINE	-10.42 -9.55	-7.05	-7	2 4	-6.5	-5.		00	1.5	ın	8.5	10	10.31	10.5	13.05	16.93	


CH 2100

DATUM R.L. 102.00		1 in -2.51 in	6	6.8%		-6.	.8%	] ¶n	-6 1 in -2.5	
DESIGN SURFACE LEVEL	106.584	108.147	108.178	107.94	107.838	107.498	107.26	107.124	104.025	
DEPTH CUT - / FILL +	0	2.29	2.9	3.19	3.16	3.04	ю	2.97		
EXISTING SURFACE LEVEL	106.58	105.86	105.28	104.75	104.68	104.46	104.26	104.15	104.03	
OFFSET FROM CENTRELINE	11.91	-8	-5	-1.5	0 0		85 5.5	10.5	18.83	

CH 2080

		1/10/12	1/10/1.8	4% 6.8%	-6.8%	4%		m11
DATUM R.L. 100.00	9	<u></u>			8 6	61 69 69 69 69 69 69 69	65	88
DESIGN SURFACE LEVEL	113.81	105.981	102.981	102.881 102.781 102.731 102.781 102.471 102.339	101.999	101.761 101.659 101.609 101.659 101.759 101.759	104.859	108.058
DEPTH CUT - / FILL +	0	-7.85	-10.78	10.72 -10.71 -10.84 -10.74 -10.74 -10.64	9.0	-10.53 -10.46 -10.47 -10.29 -10.29 -10.29	-5.43	0
EXISTING SURFACE LEVEL	113.82	113.83	113.76	113.58 113.58 113.58 113.38 113.08		112.29 112.08 112.08 112.05 112.05 111.04	110.29	108.06
OFFSET FROM CENTRELINE	-28.51	-14.8	-9.55	-7.05 -7.05 -6.81 -6.5 -5.1 -1.5	. v	8.5 10.3 10.3 10.5 10.55 13.05	18.3	23.9

CH 2180

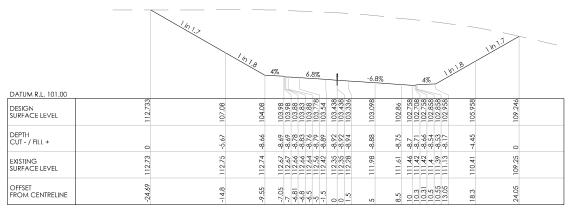

CH 2160

DATUM R.L. 102.00		lin	1.8	4% 6.8%		-6.8%		4		\m\18	>	
DESIGN SURFACE LEVEL	111.34	108.18	105.18	105.08 105.08 104.98 104.93 104.98	104.64 104.538 104.538	104.198	103.96	103.808	103.958 103.958 104.058	107.058	108.344	
DEPTH CUT - / FILL +	0	-2.92	-5.69		-6.09 -6.15 -6.15	-6.22	-6.2	-6.17	5.99	-1.79	0	
EXISTING SURFACE LEVEL	111.34	11.1	110.87	110.84 110.84 110.84 110.84 110.84	110.73 110.69 110.69	110.42	110.16	109.97	109.95	108.85	108.34	
OFFSET FROM CENTRELINE	-20.33	-14.8	-9.55	-7.05 -7 -6.81 -6.8 -6.5	000	5	8.5	10.3	10.5 10.55 13.05	(7)	20.55	

CH 2140

REVISION	AMENDMENT	APPROVED	DATE
		1	

Original sheet size A1 (841x594) Plot Date 2021-07-29 at 1:44:17 PM







Private Bag 6019 Napier 4142 New Zealand

TRANSPORT

	SCALES 1:250 [A1], 1:500 [A3]		ORIGINAL SIZE A1	PROJECT WAKA - SH2 R
	DRAWN	DESIGNED	APPROVED	0
	P. BIRSE	A. LEWIS	-	REALIG
				TITLE
	DRAWING VERIFIED	DESIGN VERIFIED	APPROVED DATE	CROS
	A. LEWIS	J. TAYLOR	=	SHEET
- 1				WOD DDG IE

-		II NZ TRANSPORT AGENCY 11.600-592/2.500 WAIKARE G IT	ORGE	
-	CROSS SECT SHEETS 1 TC			
	wsp project no. 2-S5416.01	PROJ-ORIG-VOL-LOC-TYPE WGR-DES-GEM-00-DRG	SHEET NO. 0165	F

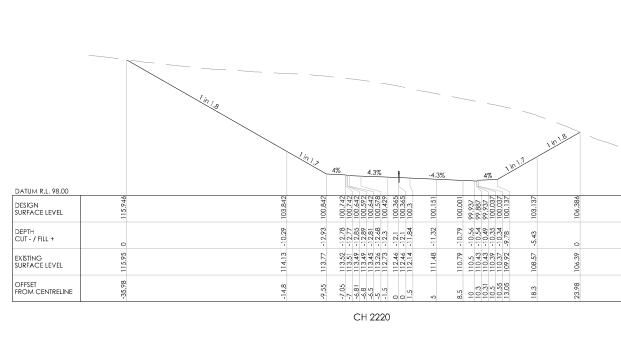

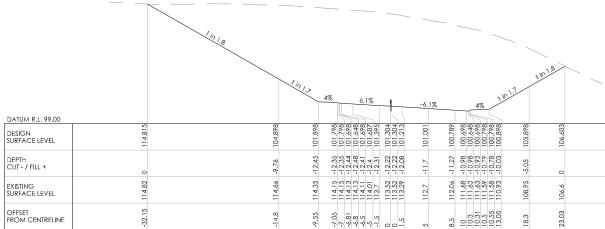

REVISION	AMENDMENT	APPROVED	DATE





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1:250 [A1], 1:500 [A3]		Δ1
DRAWN	DESIGNED	APPROVED
P. BIRSE	A. LEWIS	-
DRAWING VERIFIED	DESIGN VERIFIED	APPROVED DATE
A. LEWIS	J. TAYLOR	≘

FOR INFORMATION


OVED	RE
	TITLE
OVED DATE	CR
	SH


WAKA KOTAHI NZ TRANSPORT AGENCY SH2 R.P. 577/11.600-592/2.500 WAIKARE GORGE REALIGNMENT ROSS SECTIONS HEETS 1 TO 43 SHEET NO. 0166 WSP PROJECT NO. 2-S5416.01

WGR-DES-GEM-00-DRG

REVISION

TRANSPORT

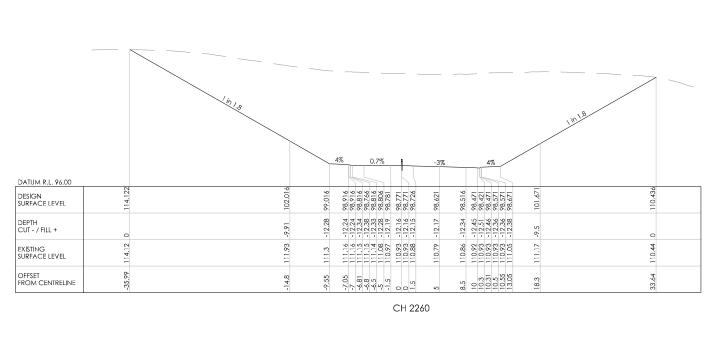

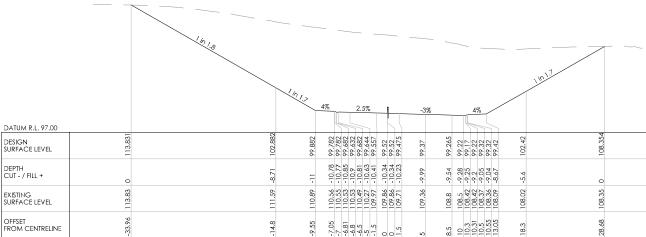

REVISION	AMENDMENT	APPROVED	DATE

Original sheet size A1 (841x594) Plot Date 2021-07-29 at 1:44:41 PM



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TRANSPORT


SCALES 1:250 [A1], 1:500 [A3] ORIGINAL SIZE DRAWN P. BIRSE A. LEWIS DRAWING VERIFIED A. LEWIS


J. TAYLOR	-
FOR INFORM	IATION

WAKA KOTAHI NZ TRANSPORT AGENCY SH2 R.P. 577/11.600-592/2.500 WAIKARE GORGE REALIGNMENT

CROSS SECTIONS SHEETS 1 TO 43

SHEET NO. 0167 2-S5416.01 WGR-DES-GEM-00-DRG

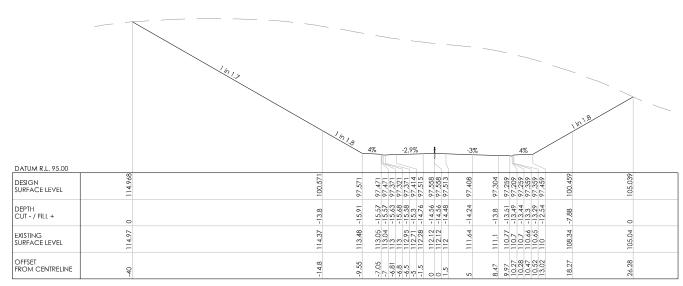

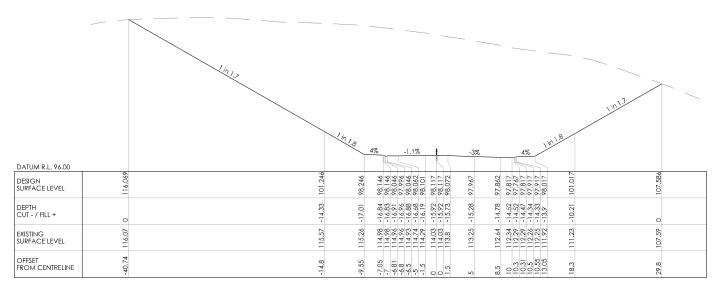

CH 2280

REVISION	AMENDMENT	APPROVED	DATE





TRANSPORT


SCALES 1:250 [A1], 1:500 [A3] ORIGINAL SIZE Private Bag 6019 Napier 4142 New Zealand P. BIRSE A. LEWIS DRAWING VERIFIED A. LEWIS J. TAYLOR


FOR INFORMATION	

WAKA KOTAHI NZ TRANSPORT AGENCY SH2 R.P. 577/11.600-592/2.500 WAIKARE GORGE REALIGNMENT

CROSS SECTIONS SHEETS 1 TO 43

SHEET NO. 0168 2-S5416.01 WGR-DES-GEM-00-DRG

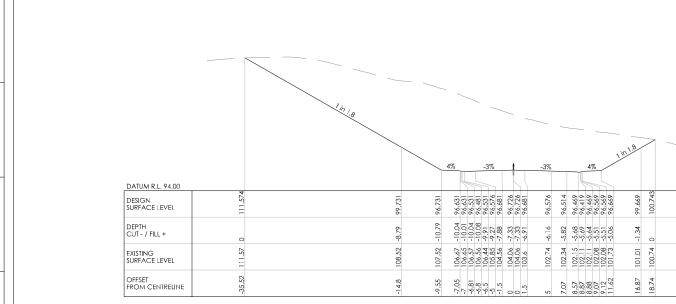

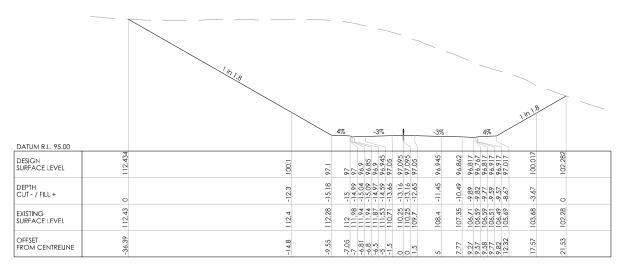

CH 2320

REVISION	AMENDMENT	APPROVED	DATE



wsp Napier Office +64 6 833 5100

Private Bag 6019 Napier 4142 New Zealand

TRANSPORT

P. BIRSE A. LEWIS A. LEWIS J. TAYLOR

SCALES

1:250 [A1], 1:500 [A3]


FOR INFORMATION

WAKA KOTAHI NZ TRANSPORT AGENCY SH2 R.P. 577/11.600-592/2.500 WAIKARE GORGE REALIGNMENT

CROSS SECTIONS SHEETS 1 TO 43

ORIGINAL SIZE

SHEET NO. 0169 REVISION 2-S5416.01 WGR-DES-GEM-00-DRG

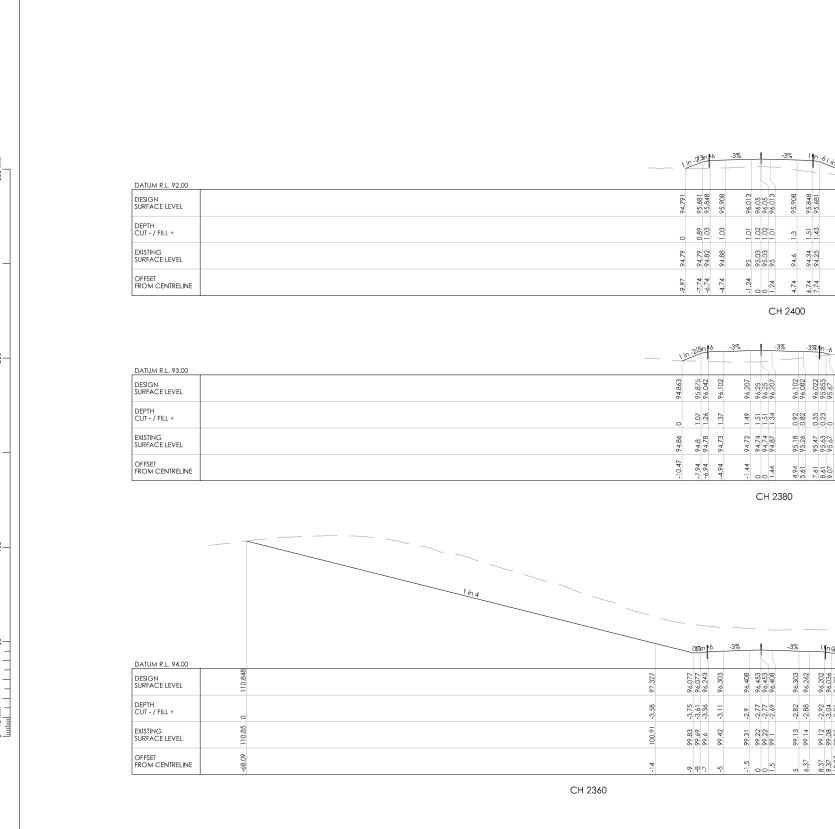

_ 7	lin4										
			)gan F	-3%	5		-3%	1¶n 0%	1 in 4		
110.848	97.337	740.94	96.077 96.243	96.303	96.408	76.453 96.453 96.408	96.303	96.202 96.036 96.036	97.286	97.827	
0	8 9	-3.75	-3.36	3.11	-2.9	-2.77	-2.82	-2.92 -3.04 -3.01	-	0	
110.85		99.83	9.66	99.42	99.31	99.22 99.1	99.13	99.12 99.08 99.05	98.29	97.83	
-68.09	7	6-	8 1-	-5-	-1.5	1.5	5 6.37	8.37 9.37 10.37	15.37	17.53	
	CH 2360										

REVISION	AMENDMENT	APPROVED	DATE

Original sheet size A1 (841x594) Plot Date 2021-07-29 at 1:45:15 PM



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TRANSPORT

1.01

CH 2400


CH 2380


ORIGINAL SIZE A1 SCALES 1:250 [A1], 1:500 [A3] P. BIRSE A. LEWIS DRAWING VERIFIED A. LEWIS J. TAYLOR FOR INFORMATION


WAKA KOTAHI NZ TRANSPORT AGENCY SH2 R.P. 577/11.600-592/2.500 WAIKARE GORGE REALIGNMENT

CROSS SECTIONS SHEETS 1 TO 43

SHEET NO. 0170 2-S5416.01 WGR-DES-GEM-00-DRG

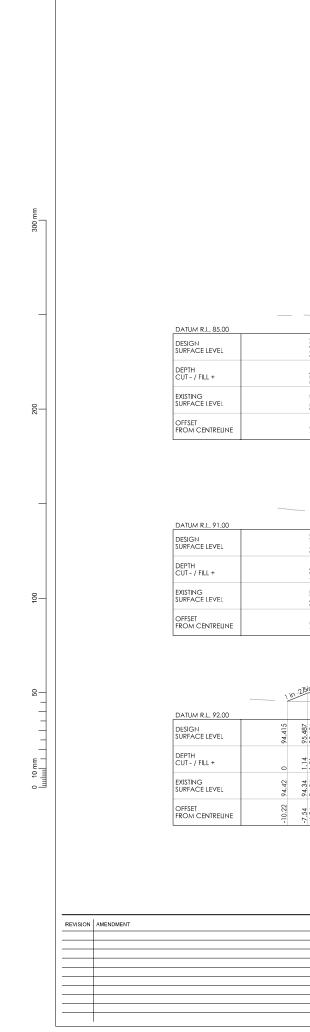

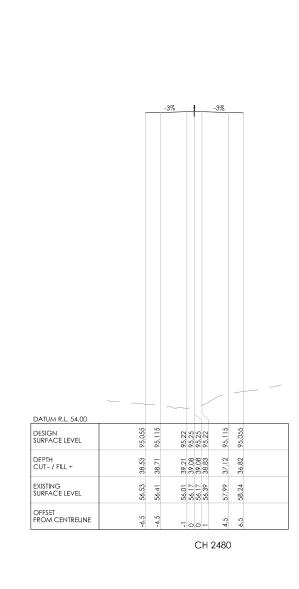

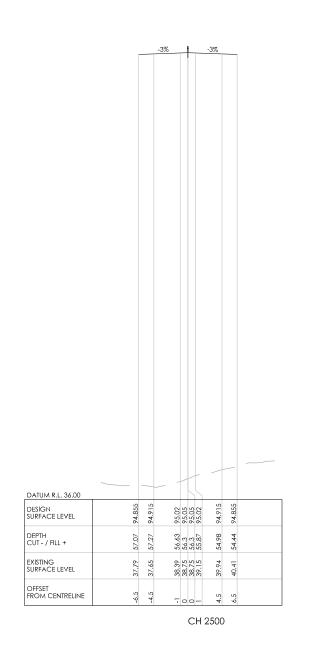

APPROVED	DATE	
		4-

8.16 8.05 8.05 7.47 7.47 5.26

87.26 87.4 87.4 87.95 90.06

CH 2460

95.62 95.65 95.65 95.62 95.515 95.455

2.06 2.16 2.16 2.21 2.21 2.21 2.17

93.56 93.49 93.49 93.41 93.34

CH 2440

95.819 95.85 95.85 95.819

1.63 1.73 1.73 1.94 1.94 1.91

CH 2420

WAKA KOTAHI NZ TRANSPORT AGENCY

1115	)
Napier C	Office
+64 6 833 5	100

Private Bag 6019 Napier 4142 New Zealand

TRANSPORT

 SCALES
 ORIGINAL SIZE

 1:250 [A1], 1:500 [A3]
 A1

 DRAWN
 DESIGNED
 APPROVED

 P. BIRSE
 A. LEWIS

 DRAWING VERIFIED
 DESIGN VERIFIED
 APPROVED DATE

 A. LEWIS
 J. TAYLOR

WAKA KOTAHI NZ TRANSPORT AGENCY SH2 R.P. 577/11.600-592/2.500 WAIKARE GORGE REALIGNMENT
TITLE CROSS SECTIONS

FOR INFORMATION


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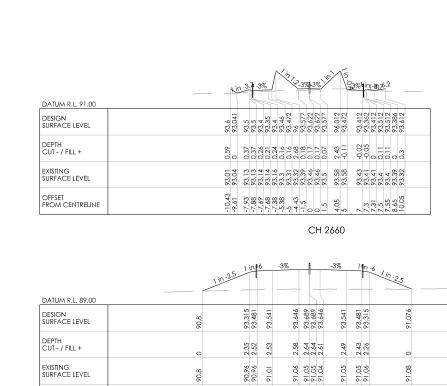
CROSS SECTIONS


SHEETS 1 TO 43

WSP PROJECT NO. PROJ-ORIG-VOL-LOC-TYPE SHEET NO. REVISION


2-S5416.01 WGR-DES-GEM-00-DRG 0171 A



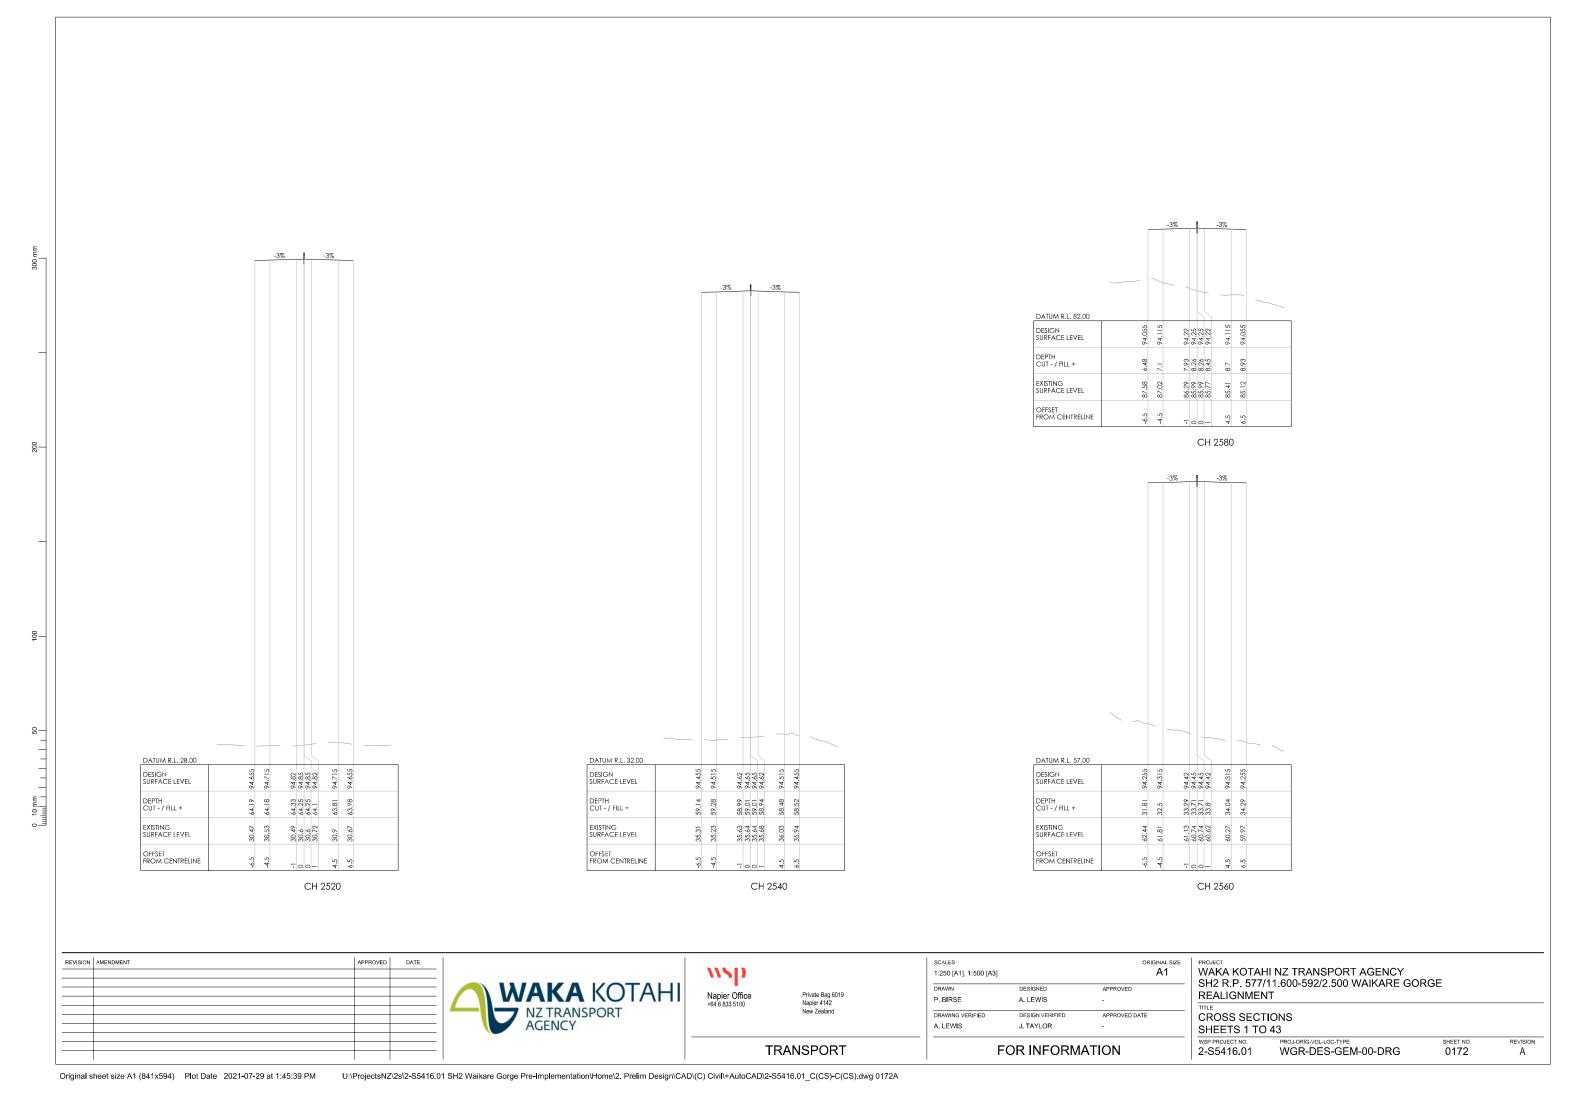


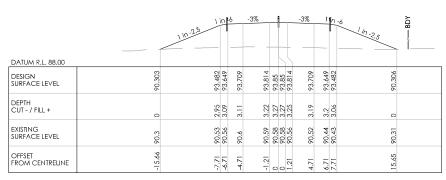

CH 2620

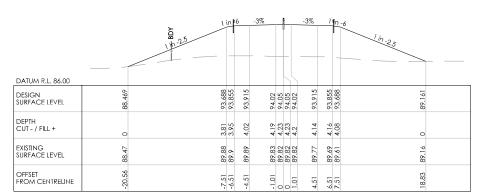

CH 2600

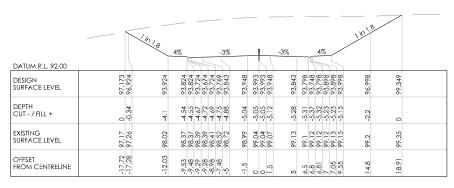

CH 2720

	15.7 A% 3% 4% 18.5 A
DATUM R.L. 91.00	
DESIGN SURFACE LEVEL	94,449 93.3411 93.6117 93.6219 93.6219 93.624 93.624 93.624 93.624 93.624 93.624 93.624 93.624 93.624
DEPTH CUT - / FILL +	0 0 0 82 0 0 0 0 0 0 0 0 0 0 0 0 0 0 0 0
EXISTING SURFACE LEVEL	94.45 94.33 94.77 94.77 94.77 94.77 94.77 94.77 95.53 95.57 95.57 95.57 95.57 95.57 95.57
OFFSET FROM CENTRELINE	11.183 9.28 9.28 9.09 9.09 9.09 9.09 1.5 5 5 5 5 7.3 1.3 1.3 1.3 1.3 1.3 1.3 1.3 1.3 1.3 1

CH 2700

													ت.	
DATUM R.L. 91.00		4%			3%			-3%	1	Ę	4%	1	<u>"</u>	
DESIGN SURFACE LEVEL	93.915	93.508	93.408	93.408	93.5	93.605	93.65 93.65 93.605	93.5	93.44	93.39	93.44	93.54	03.64	94.934
DEPTH CUT - / FILL +	0-0.31	-0.45	-0.56	-0.56	-0.56	-0.68	-0.73	-1.17	-1.34		3			0
EXISTING SURFACE LEVEL	93.91 93.91	93.96	93.96	93.97	94.06	94.29	94.38 94.38	94.68	94.78	94.79	94.79	0.4.0	04.00	94.93
OFFSET FROM CENTRELINE	-11.67	-8.63	-8.39	8.08	2.09	-1.5	00-		7	7.3	7.3	7.55	10.05	12.31

CH 2680

REVISION	AMENDMENT	APPROVED	DATE

OFFSET FROM CENTRELINE





Private Bag 6019 Napier 4142 New Zealand

TRANSPORT

SCALES 1:250 [A1], 1:500 [A3]		original size A1	WAK
DRAWN	DESIGNED	APPROVED	-   SH2
P. BIRSE	A. LEWIS	-	REAL
DRAWING VERIFIED	DESIGN VERIFIED	APPROVED DATE	CRO
A. LEWIS	J. TAYLOR	÷	SHE

FOR INFORMATION


WAKA KOTAHI NZ TRANSPORT AGENCY SH2 R.P. 577/11.600-592/2.500 WAIKARE GORGE REALIGNMENT
CROSS SECTIONS SHEETS 1 TO 43


WGR-DES-GEM-00-DRG

2-S5416.01

REVISION

SHEET NO. 0173

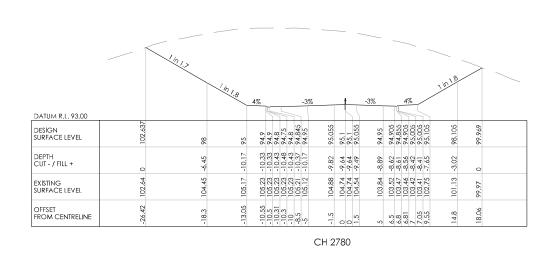

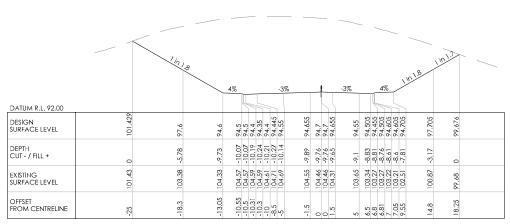

DATUM R.L. 92.00 DESIGN SURFACE LEVEL DEPTH CUT - / FILL + EXISTING SURFACE LEVEL OFFSET FROM CENTRELINE

CH 2760


CH 2740

										_		_	_	_	_		
DATUM R.L. 94.00	14	1.84	1%				-3%		-	7	-3%		49		<u>)</u>	01.8	
DESIGN SURFACE LEVEL	97.243	96.2	96.1	96	95.95	96 045	96.15	96.255	6.96	96.3 96.255	96.15	96.105	96.105	96.205	96.305	99,305	99.387
DEPTH CUT - / FILL +	0	-1.54	-2.25	-2.44	-2.49	2.54	3.88	-4.65	-4.92	-4.92	-5.44	-5.24	-5.19	-5.06	4.53	0.13	0
EXISTING SURFACE LEVEL	$\sim$	97.74	98.35	98.44	98.44	98 98	100.03	100.9	5	101.22	101.59	101.34	101.29	101.27	100.83	99.43	99.39
OFFSET FROM CENTRELINE	-14.88	-13.05	-10.55	-10.31	-10.3	28.5	5	-1.5	0	1.5	5	6.5	6.81	7 05	9.55	8,4	14.94

CH 2840

				_	_	_	_	_	_		_	_		_	_	_	_	-	-	_				
	/	12	1.2/10/1.8												007				1%		الْرِ	18	>	
DATUM R.L. 94.00				4%	Ų				-3'	%		-	\	7	-3%		7	5	170	5				
DESIGN SURFACE LEVEL	99.396	98.8	95.8	7 10	95.7	95.6	95.55	5.6	95.75		95.855	95.9	- 10	75.855	95.75		75.705	75.655	95.805	95.805	75.905	98.905	99.736	
DEPTH CUT - / FILL +	0	6.0	-5.39	90.7	-6.03	-6.23	-6.28	-6.29	-6.84		-7.08	7.11	-7.11	-/.09	, Y	5 .	-6.58	6.28	623	-6.38	9/:0-	-1.28	0	
EXISTING SURFACE LEVEL	4.99	2.66	101.19	02	101.7	101.83	101.83	101.89	102.59		102.93	103	103	102.94	102 57	0.10	102.29	102.23	102.2	102.19	99:10	100.18	99.74	
OFFSET FROM CENTRELINE	-19.34	-18.3	-13.05	39 01	-10.33	-10.31	-10.3	٥- ز	-5.5		-1.5	0	0,	ď.	ır	, :	6.5	2.0	0.0	7.05	7.55	14.8	16.25	

CH 2820

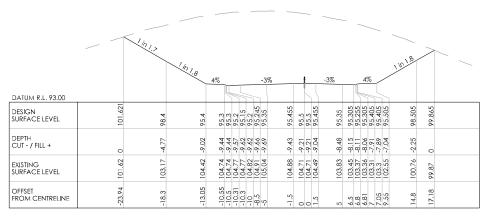

CH 2800

REVISION	AMENDMENT	APPROVED	DATE
	1	1	



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Napier C +64 6 833 5	Office 100


Private Bag 6019 Napier 4142 New Zealand

SCALES 1:250 [A1], 1:500 [A3]		original s A1	SIZE	PROJECT WAKA KOTAHI NZ TRANSPORT AGENCY SH2 R P 577/11 600-592/2 500 WAIKARF G
DRAWN P. BIRSE	DESIGNED A. LEWIS	APPROVED		REALIGNMENT
DRAWING VERIFIED	DESIGN VERIFIED	APPROVED DATE	—	TITLE CROSS SECTIONS
A. LEWIS	J. TAYLOR	-		SHEETS 1 TO 43

O		RGE
0000		
wsp project no. 2-S5416.01	PROJ-ORIG-VOL-LOC-TYPE WGR-DES-GEM-00-DRG	SHEET NO. 0174
	REALIGNMENT TITLE CROSS SECTIO SHEETS 1 TO 4 WSP PROJECT NO.	CROSS SECTIONS SHEETS 1 TO 43  WSP PROJECT NO. PROJ-ORIG-VOL-LOC-TYPE

REVISION

TRANSPORT

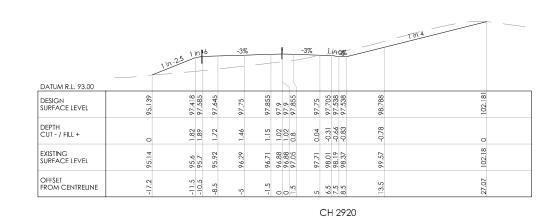

DATUM R.L. 93.00

DESIGN SURFACE LEVEL

DEPTH CUT - / FILL +

EXISTING SURFACE LEVEL

EXISTING SURFACE LEVEL

OFFSET FROM CENTRELINE

PART OF STATE OF STATE

CH 2900

		1 in app	in 6 -	-3%	5	-	-3%	1 i	n -6	
DATUM R.L. 94.00										
DESIGN SURFACE LEVEL	97 036	96.618	96.785	96.95	97.055	97.1 97.055	96.95	96.905 96.738	96.518	
DEPTH CUT - / FILL +	c	0.44	-0.32	-0.14	0.18	0.34	0.48	0.43	0	
EXISTING SURFACE LEVEL	97.04	97.06	97.11	97.09	96.87	96.76	96.47	96.47	96.52	
OFFSET FROM CENTRELINE	-1417	2.5	-10.5	-5-	-1.5	0.1.5	5	6.5	8.82	


CH 2880

		ı in	6	_	-3%			+	_	-3%	-1	in	98%	1 in 4		
DATUM R.L. 94.00			\						1							
DESIGN SURFACE LEVEL	95.958	96.218	96.385	96.445	96.55	96.655	2.96	296	96.655	96.55	94 505	96.338	96.338	97.588		
DEPTH CUT - / FILL +	0	0.25	0.37	0.39	0.21	0.02	-0.13	-0.13	-0.48	-1.37	-1 44	-1.97	-2.13	-1.22	0	
EXISTING SURFACE LEVEL	95.96	95.97	10.94	96.05	96.34	96.63	96.83	96.83	97.14	97.92	98 14	98.31	98.47	98.81	98.44	
OFFSET FROM CENTRELINE	2	-11.5	<u> </u>	-8.5	5	-1.5	0		5.			7.5		13.5	16.91	

CH 2860

		.251 in 16	-3%		3% lin 0%	1 in 4	
DATUM R.L. 94.00							
DESIGN SURFACE LEVEL	96.386	98.218 98.385 98.445	98.55	98.655 98.7 98.7 98.655	98.55 98.505 98.338 98.338	99.588	
DEPTH CUT - / FILL +	0	1.65	1.52	0.77 0.77 0.49	-0.23 -0.55 -0.9	0.43	
EXISTING SURFACE LEVEL	96.39	96.57 96.59 96.67	97.03	97.65 97.93 97.93 98.16	98.78 99.06 99.24 99.43	100.02	
OFFSET FROM CENTRELINE	-16.08	-11.5 -10.5 -8.5	9	-1.5 0 0 1.5	5 6.5 7.5 8.5	13.5	

CH 2960

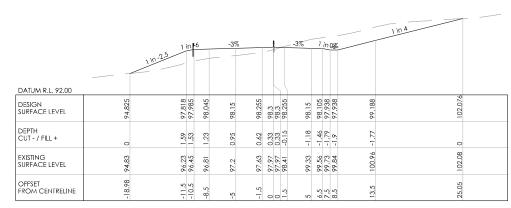

CH 2940

REVISION	AMENDMENT	APPROVED	DATE

Original sheet size A1 (841x594) Plot Date 2021-07-29 at 1:46:14 PM



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Napier C	Office
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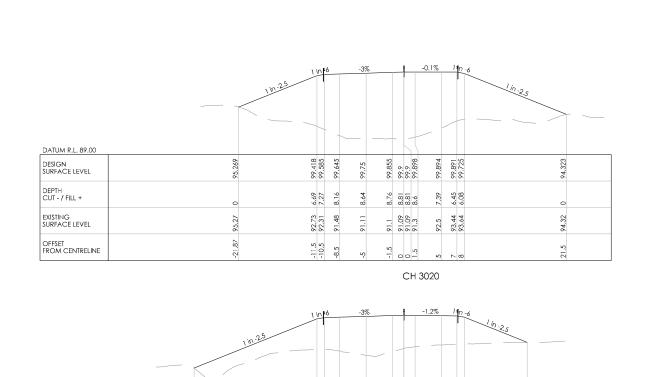
Private Bag 6019 Napier 4142 New Zealand

TRANSPORT


SCALES 1:250 [A1], 1:500 [A3]		ORIGINAL S A1
DRAWN	DESIGNED	APPROVED
P. BIRSE	A. LEWIS	=
DRAWING VERIFIED	DESIGN VERIFIED	APPROVED DATE
A. LEWIS	J. TAYLOR	_

ORIGINAL SIZE A1	WAKA KOTAHI NZ TRANSPORT AGENCY SH2 R.P. 577/11.600-592/2.500 WAIKARE GORGE REALIGNMENT
DATE	TITLE CROSS SECTIONS

CROSS SECT			
WSP PROJECT NO.	PROJ-ORIG-VOL-LOC-TYPE	SHEET NO.	REVISION
2-S5416.01	WGR-DES-GEM-00-DRG	0175	Α



4.81 4.37 4.13 4.13 3.87 3.87 3.57

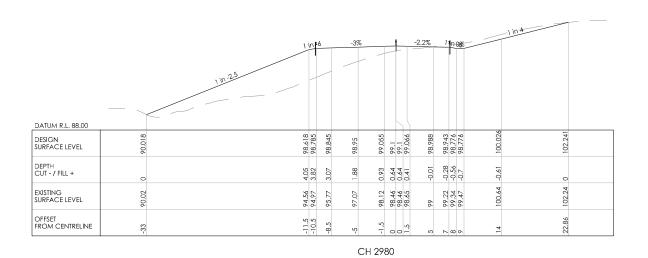

		1 in -2.5	1 in	5	-3%		-		0.9%	1 <b>f</b> r	1-6 1 in -2.5	
DATUM R.L. 91.00					_		-	+		_		
DESIGN SURFACE LEVEL	96.075		99.818	100.045	100.15	100.255	100.3	100.314	100.347	100.365	97.215	
DEPTH CUT - / FILL +	0		5.48	5.43	5.66	6.1	6.29	6.29	99.9	6.21	0	
EXISTING SURFACE LEVEL	70.94		94.34	94.61	94.49	94.15	94	93.68	93.69	94.15	97.22	
OFFSET FROM CENTRELINE	-20.86		-11.5	-8.5	ç,	-1.5	0	1.5	22	<b>/</b> α	15.46	

REVISION	AMENDMENT	APPROVED	DATE

DATUM R.L. 89.00 DESIGN SURFACE LEVEL

DEPTH CUT - / FILL +

EXISTING SURFACE LEVEL

OFFSET FROM CENTRELINE



11/5	)
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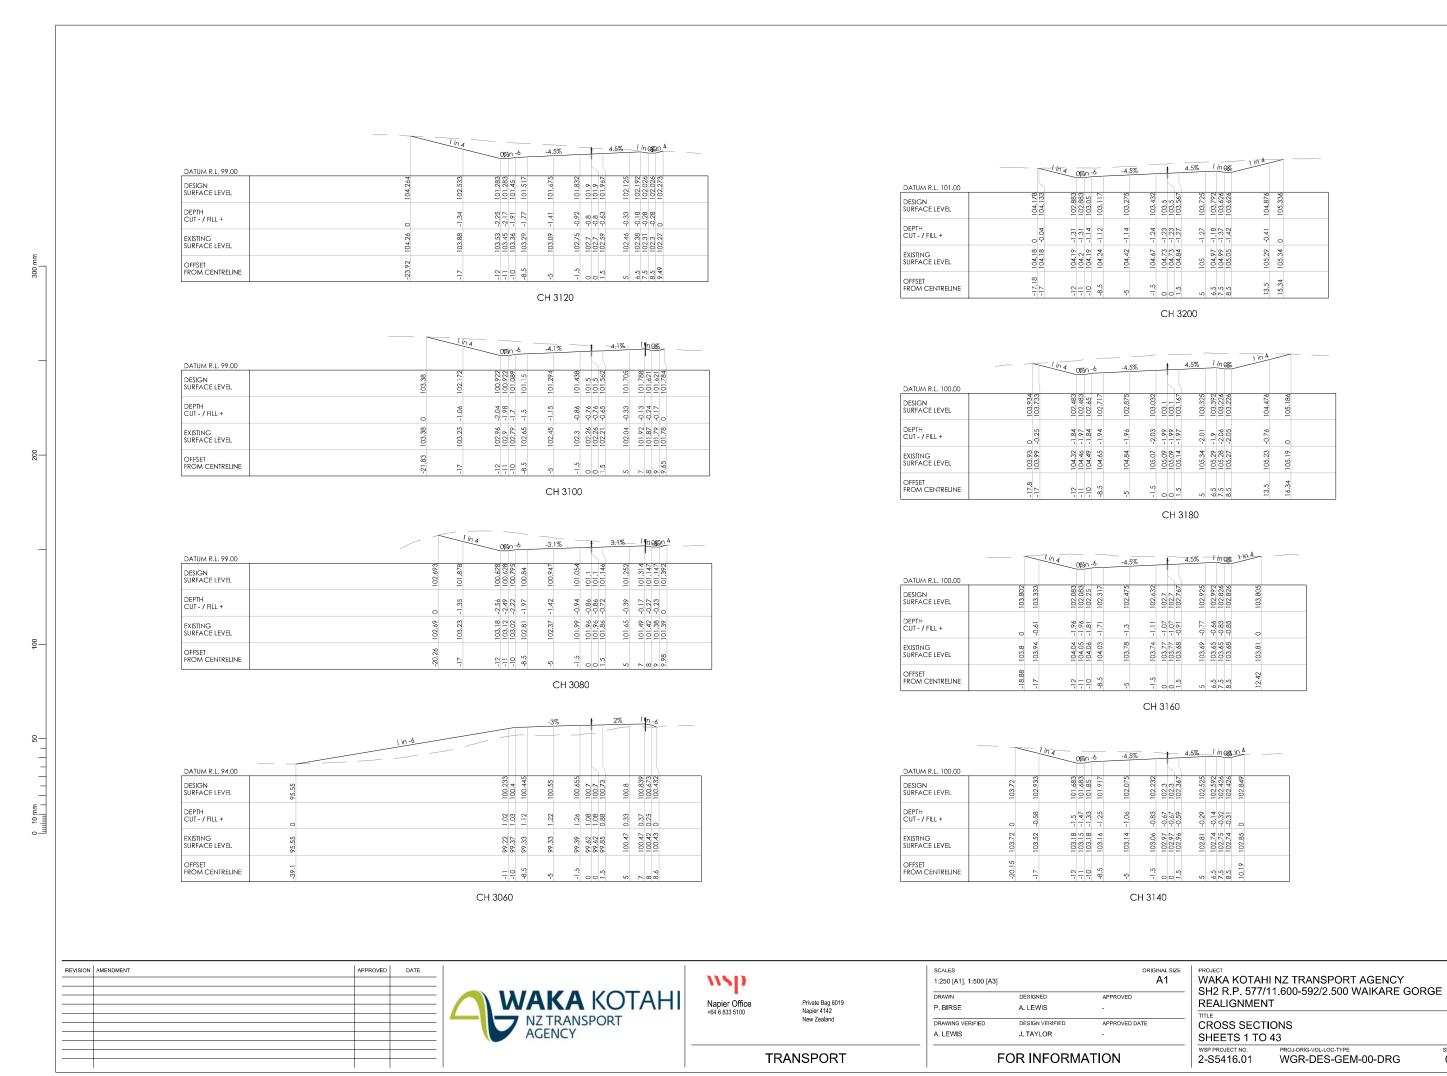
	SCALES 1:250 [A1], 1:500 [A3]		ORIGINAL SIZE A1
ı	DRAWN	DESIGNED	APPROVED
	P. BIRSE	A. LEWIS	-
ı	DRAWING VERIFIED	DESIGN VERIFIED	APPROVED DATE
	A. LEWIS	J. TAYLOR	-

FOR INFORMATION

ZE	WAKA KOTAHI NZ TRANSPORT AGENCY SH2 R.P. 577/11.600-592/2.500 WAIKARE GORGE REALIGNMENT
_	TITLE CROSS SECTIONS SHEETS 1 TO 43

CH 3040

WSP PROJECT NO. 2-S5416.01 SHEET NO. 0176 REVISION PROJ-ORIG-VOL-LOC-TYPE
WGR-DES-GEM-00-DRG



REVISION A

SHEET NO. 0177

		tin 4	09an -6	-3.3%	_	3.3% 1 in 9%	T in 4	_
DATUM R.L. 102.00								
DESIGN SURFACE LEVEL	107.373	105.453	104.203 104.203 104.37 104.419	104.535	104.65 104.7 104.7 104.749	104.865 104.914 104.748 104.748	105.998	
DEPTH CUT - / FILL +	0	-0.99	-1.86 -1.81 -1.63 -1.55	-1.35	-1.15 -1.16 -1.16	-1.09 -1.15 -1.39 -1.4	0 0	
EXISTING SURFACE LEVEL	107.37	106.44	106.06 106.02 106	105.89	105.8 105.86 105.86 105.86	106.95 106.07 106.14 106.15	106.21	
OFFSET FROM CENTRELINE	-24.68	-17	-12 -11 -10	-5	-1.5 0 0 1.5	5 6.5 7.5 8.5	13.5	

CH 3260

		l in 4	09%n	-6	-4.4%		4.4%	1 in 9%	1 in 4	
DATUM R.L. 102.00							.\			
DESIGN SURFACE LEVEL	108.523	104.947	103.697	103.929	104.082	104.3	2 2	2 2 2	105.547	
DEPTH CUT - / FILL +	0	-2.93	3.05	-2.14	-1.72	-1.21			0	
EXISTING SURFACE LEVEL	108.52	107.87	106.75	106.07		105.51	105.42		105.55	
OFFSET FROM CENTRELINE	-31.3	21-	21-12	8.5	ځ .	c: 00	5. 5.	6.5 7.5 8.5	13.02	

CH 3240

		I in 4		18an -	6	-4.5%	_		4.5%	-1 ir	198%	+in 4
DATUM R.L. 101.00												
DESIGN SURFACE LEVEL	107.511	104.533	103.283	103.283	103.517	103.675	103.832	103.9 103.9 103.967	104.125	104.192	104.026	105.276 105.367
DEPTH CUT - / FILL +	0	-1.79	-2.43	-2.27	-1.87	-1.51	-1.26	-1.14	-0.75	0.73	-0.94	0.08
EXISTING SURFACE LEVEL	107.51	106.33	105.71	105.55	105.39	105.18	105.1	105.04 105.04 104.99	104.88	104.92	104.97	105.36
OFFSET FROM CENTRELINE	-28.91	-17	12		-8.5	5	-1.5	0 0 1.5	5	6.5		13.5

CH 3220

REVISION	AMENDMENT	APPROVED	DATE

Original sheet size A1 (841x594) Plot Date 2021-07-29 at 1:46:51 PM





SCALES 1:250 [A1], 1:500 [A3] ORIGINAL SIZE Private Bag 6019 Napier 4142 New Zealand P. BIRSE A. LEWIS DRAWING VERIFIED

A. LEWIS J. TAYLOR

FOR INFORMATION

WAKA KOTAHI NZ TRANSPORT AGENCY SH2 R.P. 577/11.600-592/2.500 WAIKARE GORGE REALIGNMENT

CROSS SECTIONS SHEETS 1 TO 43

SHEET NO. 0178 2-S5416.01 WGR-DES-GEM-00-DRG

			1 in 4
	1 in 2073m -6	0.9% -0.9% 1 in 0%	
DATUM R.L. 104.00			
DESIGN SURFACE LEVEL	106.7 106.227 106.227 106.379		107.322
DEPTH CUT - / FILL +	0 -0.68 -0.73 -0.89	-1.25 -1.66 -1.87 -2.08 -2.56 -2.71 -2.94	0
EXISTING SURFACE LEVEL	106.7 106.91 107.02 107.13		109.23
OFFSET FROM CENTRELINE	-13.89 -12 -11 -10 -8.5	[	22.93

							_			1 in 4
DATINA DA 104.00		11	in 4 08/an -6	-0.1%			0.1%	1 in 08	80	
DESIGN SURFACE LEVEL	107.404	106.971	105.721 105.721 105.888 105.889	105.894	105.898	105.9 105.902	105.906	105.741	106.991	110.974
DEPTH CUT - / FILL +	0	-0.58	-2.26 -2.34 -2.27 -2.38	-2.73	-3.06	-3.21 -3.21 -3.35	-3.6	-3.73	3.28	O
EXISTING SURFACE LEVEL	107.4	107.55	107.98 108.06 108.15 108.27	108.62	08.9	109.11	109.51	109.64	110.27	110.97
OFFSET FROM CENTRELINE	-18.73	-17	-12 -11 -10 -8.5	ç	-1.5	0 0	50	6.5 7.5 8.5	13.5	29.43

CH 3320

		1 in 4							_		1 in 4		` _
DATUM R.L. 103.00			08/sn -6	-1.2%			1.2%	1 in					
DESIGN SURFACE LEVEL	107.663	106.465	105.215 105.215 105.382 105.399	105.441	105.482	105.518	105.559	105.577	105.41	106.66		112.031	
DEPTH CUT - / FILL +	0	-1.7	-3.46 -3.52 -3.42 -3.5	-3.75	4.02	-4.29	-4.56	4.64	-4.89	-3.79		0	
EXISTING SURFACE LEVEL	107.66	108.17	108.67 108.73 108.81 108.9	109.19	109.64	109.81	110.11	110.22	110.3	110.45		112.03	
OFFSET FROM CENTRELINE	21.79	-17	-12 -11 -10 -8.5	ro.	-1.5	5.	ıo.	6.5	9.5	13.5		34.98	

CH 3300

REVISION	AMENDMENT	APPROVED	DATE

Original sheet size A1 (841x594) Plot Date 2021-07-29 at 1:47:03 PM



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Private Bag 6019 Napier 4142 New Zealand

TRANSPORT

SCALES 1:250 [A1], 1:500 [A3]		ORIGINAL SIZE A1
DRAWN	DESIGNED	APPROVED
P. BIRSE	A. LEWIS	-
DRAWING VERIFIED	DESIGN VERIFIED	APPROVED DATE
A. LEWIS	J. TAYLOR	-

FOR INFORMATION


	T
APPROVED DATE	(
-	5


WAKA KOTAHI NZ TRANSPORT AGENCY SH2 R.P. 577/11.600-592/2.500 WAIKARE GORGE REALIGNMENT

CROSS SECTIONS SHEETS 1 TO 43

WSP PROJECT NO. 2-S5416.01 WGR-DES-GEM-00-DRG

SHEET NO. 0179

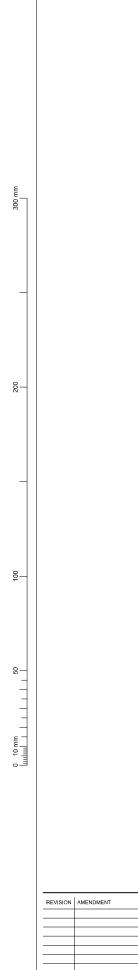

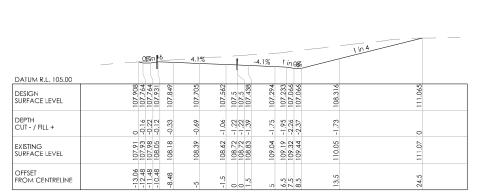

		1 in 4	08an -	6	3.1%		_	-3.1%		3 <b>%</b> ,	·	1 in 4		
DATUM R.L. 105.00														
DESIGN SURFACE LEVEL	107.859	107.239	107.239	107.359	107.253	107.146	107.1	106.947	106.901	106.735	107.985		112.172	
DEPTH CUT - / FILL +	0	-0.77	-0.81	-0.88	-1.17	-1.52	1.65	-2.27	-2.45	-2.8	-2.21		0	
EXISTING SURFACE LEVEL	107.86	108.01	108.05	108.24	108.43	108.66	108.75 108.75 108.88	109.22	109.35	109.54	110.2		112.17	
OFFSET FROM CENTRELINE	-14.48	-12		-8.5	ę,	-1.5	0 0	5	6.5		13.5		30.25	

CH 3380

										_		1 in 4		
		1 in 40%	n-6	2%		-	-2%		1 in	<b>08%</b>				
DATUM R.L. 104.00														
DESIGN SURFACE LEVEL	107.388		106.899	106.8	106.73	106.7	/9:9/	9.901	106.57	106.404	107.654		112.157	
DEPTH CUT - / FILL +	c	0.79	-0.69	-1.15	-1.55	99.1-	80, -	-2.19	2.42	-2.88	-2.36		0	
EXISTING SURFACE LEVEL	107.39	107.52	107.59	107.95	108.28	108.38	8.48	108.79	108.99	109.29	110.01		112.16	
OFFSET FROM CENTRELINE	14.62	. 0 -	10	20	1.5		ų		5.5	.5	3.5		15.	

CH 3360

		5 1 in 6	4.5%		4.5%	1 in -6	
DATUM R.L. 105.00							
DESIGN SURFACE LEVEL	107.375	109.328 109.495 109.405	109.325	109.167 109.1 109.1 109.032	108.875 108.807 108.641	107.645	
DEPTH CUT - / FILL +	0	2.18	2.1	1.85	1.51	0	
EXISTING SURFACE LEVEL	107.37	107.33	107.23	107.24 107.25 107.25	107.37 107.46 107.49	107.64	
OFFSET FROM CENTRELINE	-14.67	-9.78 -8.78 -6.78	-5	-1.5 0 0 1.5	5 6.5 7.5	13.47	

CH 3480

		1 in -2.3 in	6	4.5%		+	-4.5%	_		in -6	
DATUM R.L. 105.00											
DESIGN SURFACE LEVEL	107.615	9.4	09.0	108.925	108.767	108.7	108.632	108.407	108.241	107.518	
DEPTH CUT - / FILL +	0	1.33	1.5	1.34	1.22	1.16	1.12	0.96	0.78	0	
EXISTING SURFACE LEVEL	107.61	107.62	107.61	107.58	107.55	107.54	107.51	107.45	107.46	107.52	
OFFSET FROM CENTRELINE	-13.54	2	-9.21 -7.21	45	-1.5	00	Z		7.5	11.84	

CH 3460

	1 in 6	4.5%	-4.5% 1 in 0% 1 in 4
DATUM R.L. 106.00			
DESIGN SURFACE LEVEL	108.541 108.567 108.733 108.643	108.525	108.367 108.3 108.32 108.07 108.007 107.841 107.841
DEPTH CUT - / FILL +	0 0.02 0.18 0.07	-0.1	0.34 -0.43 -0.51 -0.51 -1.04 -1.05
EXISTING SURFACE LEVEL	108.54 108.54 108.55 108.57	108.62	108.7 108.73 108.75 108.75 108.86 108.88 108.89
OFFSET FROM CENTRELINE	-10.69 -10.63 -9.63 -7.63	5	-1.5 0 0 0 1.5 1.5 7.5 8.5 8.5

CH 3440

-	0%n 6	4.5%	-4.5% 1 ir	1 in 4
DATUM R.L. 105.00				
DESIGN SURFACE LEVEL	108.347 108.186 108.186 108.352 108.352	108.125	107.967 107.9 107.9 107.832 107.675	
DEPTH CUT - / FILL +	0 -0.18 -0.02 -0.05	-0.47	-0.78 -0.91 -1.02 -1.34 -1.49	
EXISTING SURFACE LEVEL	108.35 108.37 108.38 108.45	108.6	108.75 108.81 108.85 108.85 109.02	
OFFSET FROM CENTRELINE	-12.7 -12.05 -11.05 -10.05	-5	-1.5 0 0 1.5 1.5 5 6.5	13.5

CH 3420

REVISION	AMENDMENT	APPROVED	DATE

Original sheet size A1 (841x594) Plot Date 2021-07-29 at 1:47:15 PM





Private Bag 6019 Napier 4142 New Zealand

TRANSPORT

SCALES 1:250 [A1], 1:500 [A3]		original siz A1
DRAWN	DESIGNED	APPROVED
P. BIRSE	A. LEWIS	-
DRAWING VERIFIED	DESIGN VERIFIED	APPROVED DATE
A. LEWIS	J. TAYLOR	=


FOR INFORMATION

ORIGINAL SIZE A1	WAKA KOTAHI NZ TRANSPORT AGENCY SH2 R.P. 577/11.600-592/2.500 WAIKARE GORGE REALIGNMENT

TITLE
CROSS SECTIONS
SHEETS 1 TO 43


WSP PROJECT NO. PROJ-ORIG-VOL-LOC-TYPE SHEET NO.
2-S5416.01 WGR-DES-GEM-00-DRG 0180


REVISION A

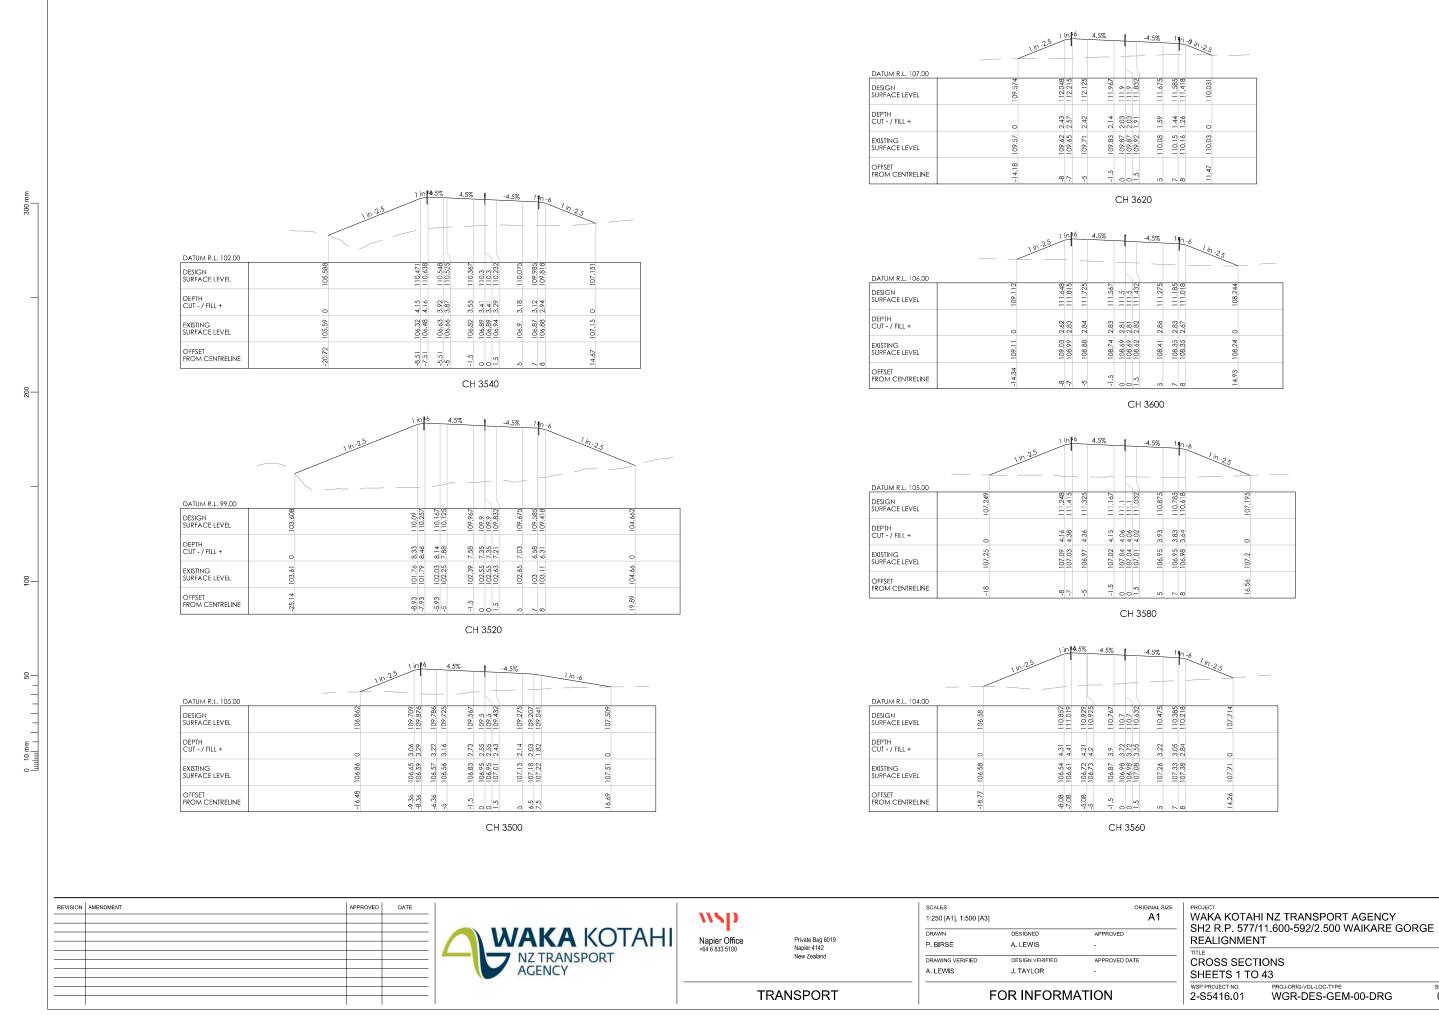


REVISION A


SHEET NO. 0181

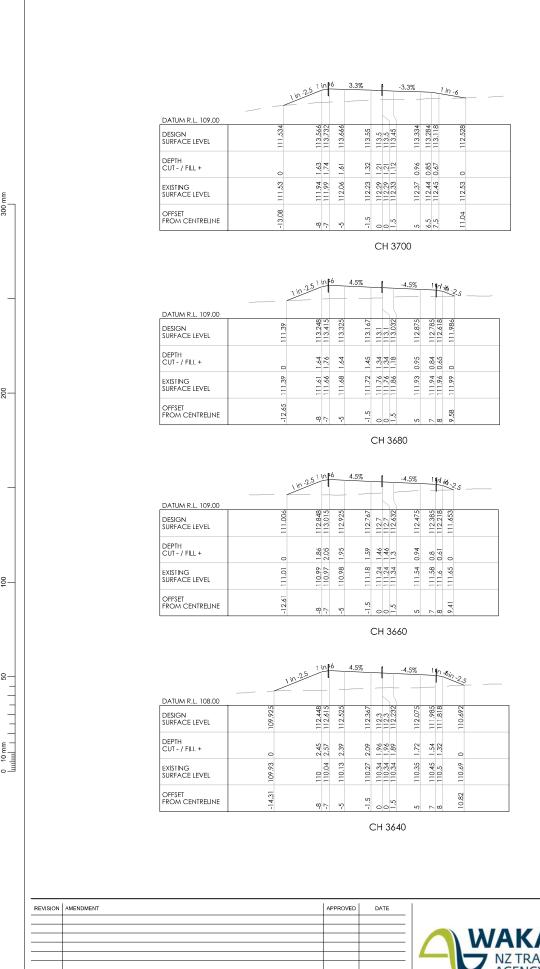

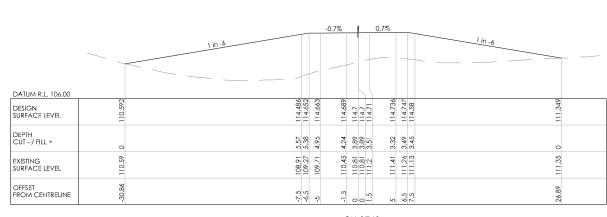

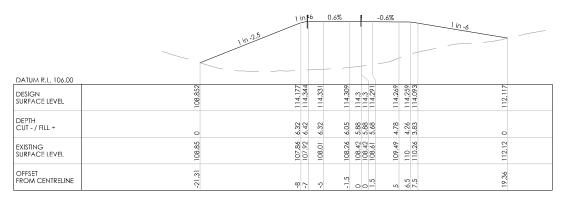

CH 3740

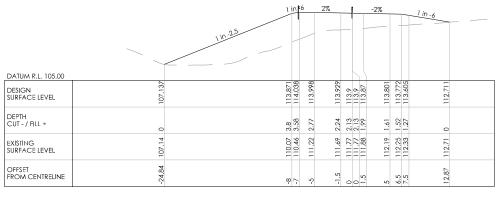

CH 3720

ORIGINAL SIZE PROJECT

REVISION	AMENDMENT	APPROVED	DATE	





Private Bag 6019 Napier 4142 New Zealand


SCALES 1:250 [A1], 1:500 [A3]		original si A1
DRAWN	DESIGNED	APPROVED
P. BIRSE	A. LEWIS	-
DRAWING VERIFIED	DESIGN VERIFIED	APPROVED DATE
A. LEWIS	J. TAYLOR	-


	NZ TRANSPORT AGENCY 1.600-592/2.500 WAIKARE G T	ORGE
CROSS SECTI SHEETS 1 TO	00	
WSP PROJECT NO. 2-S5416.01	PROJ-ORIG-VOL-LOC-TYPE WGR-DES-GEM-00-DRG	SHEET NO. 0182

REVISION

TRANSPORT

FOR INFORMATION

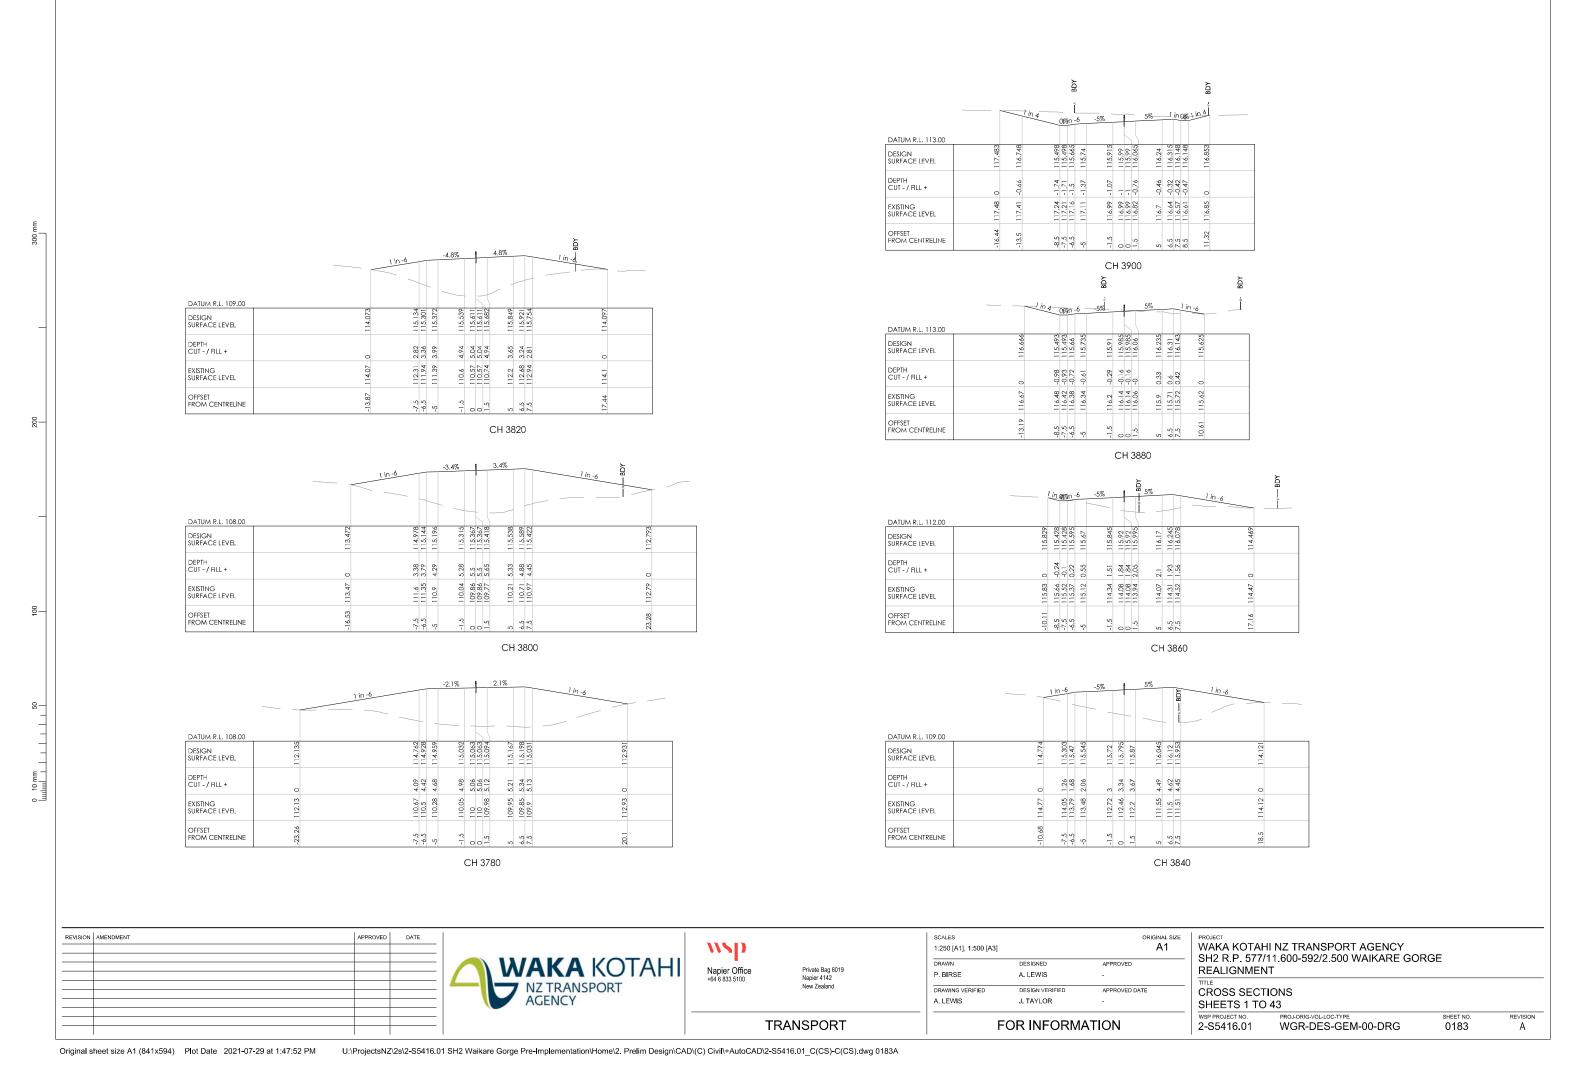


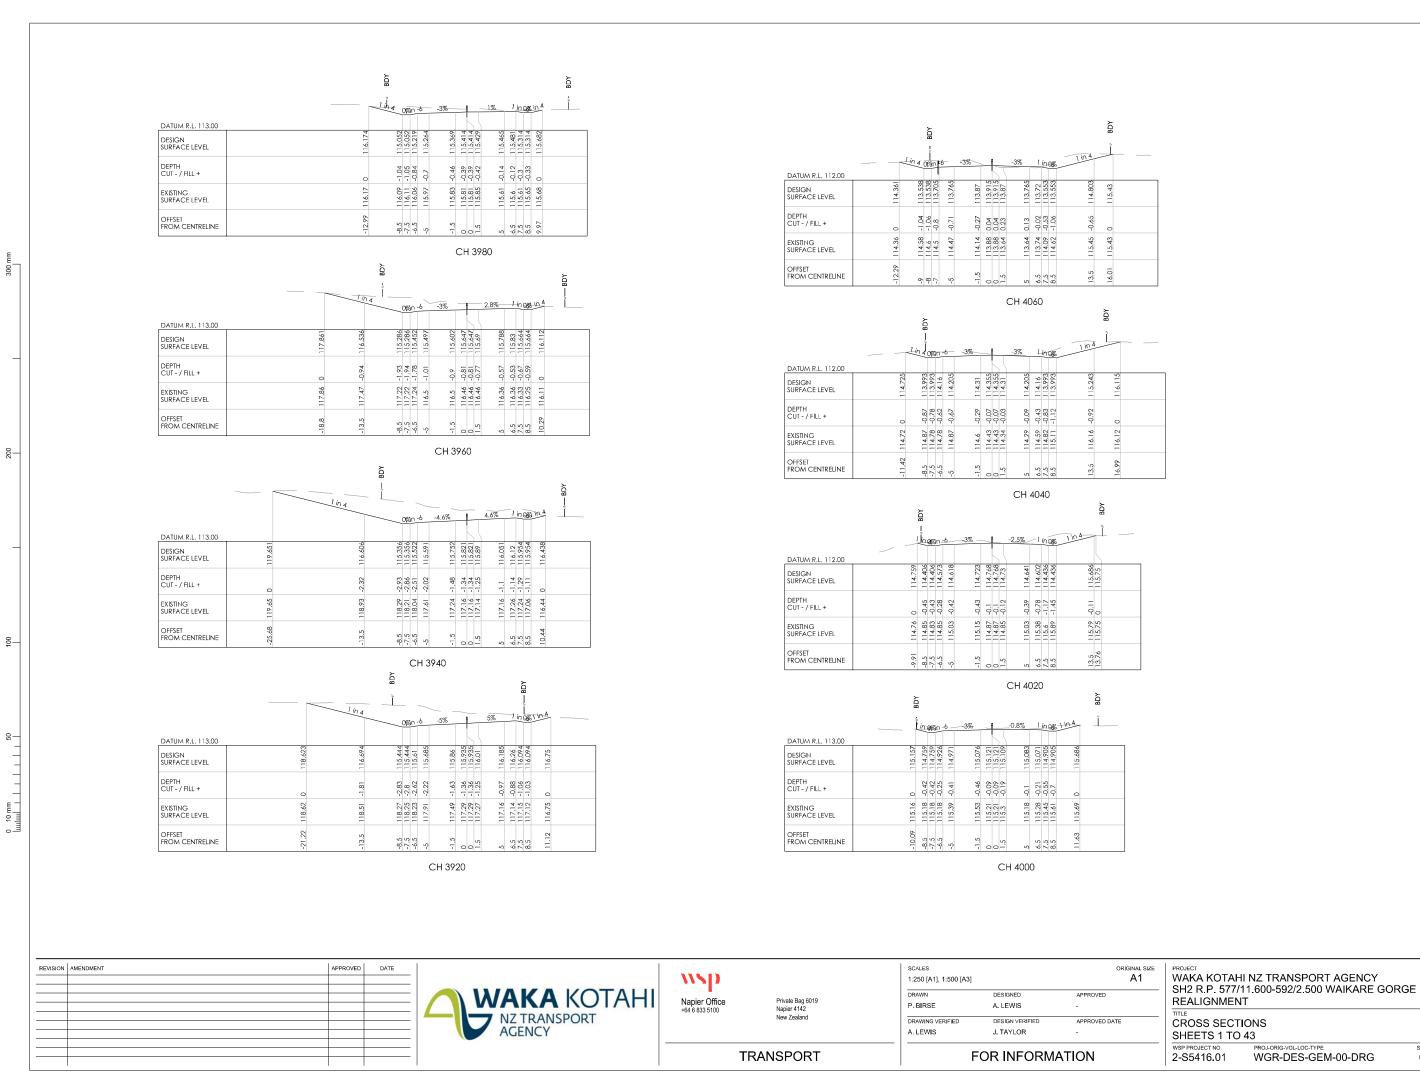


REVISION A

SHEET NO. 0184

WGR-DES-GEM-00-DRG

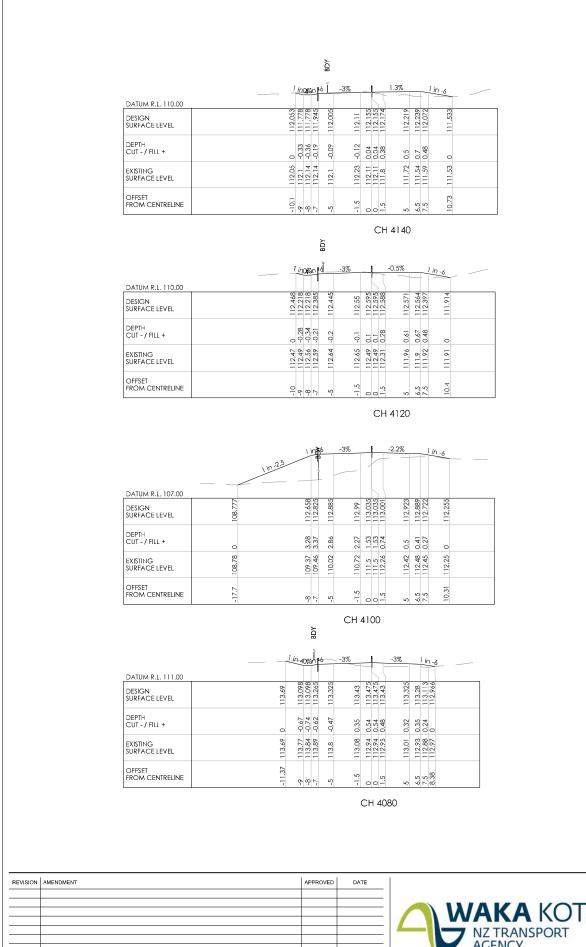

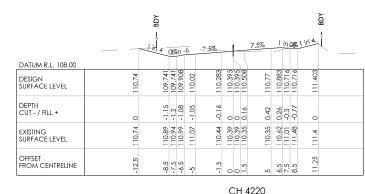

						C	7 4	1220			
		Š	ā								
		l in 4	0%n	6	-6.6%	_	7	6.6%	1	in-6	
DATUM R.L. 108.00				1							
DESIGN SURFACE LEVEL	111.341	110.208	110.208	110.506	110.736	110.835	110.934	111.164	111.263	111.096	
DEPTH CUT - / FILL +	0	-1.24	-1.28	-1.03	-0.21	80.0	0.21	0.41	0.53	0.12	
EXISTING SURFACE LEVEL	111.34	111.45	111.49	111.54	110.95	110.91	110.72	110.76	110.73	110.98	
OFFSET FROM CENTRELINE	-13.53	6-	- φ ۲	· 5-	-1.5	00	1.5	ю	6.5	7.5	

			BDY									
	 الإ	7.2.bi	nee	,	-4.8%	-		4.8%		11	n-6	
DATUM R.L. 108.00												
DESIGN SURFACE LEVEL	109.572	110.771	110.938	111.034	111.203	111.275	111.275	111.516	111.588	111.421	111.129	
DEPTH CUT - / FILL +	0	9.0	98.0	0.83	0.27	0.17	0.17	0.46	0.5	0.37	0	
EXISTING SURFACE LEVEL	109.57	109.97	110.08	110.21	110.94	111.1	111.1	111.06	111.09	111.05	111.13	
OFFSET FROM CENTRELINE	Ę	φ	-7	Ş	-1.5	0	0	ro.	5.5	7.5	9.25	

						CH 4	180			
				BDY						BDY
		1 in 40	Dran t	6 <u></u>	-3.1%		3.1%	-   -	1 in -6	1
DATUM R.L. 108.00										
DESIGN SURFACE LEVEL	111,989	111.335	111.335	111.563	111.669	111.715	111.868	111.913	110.678	
DEPTH CUT - / FILL +	0	-0.65	-0.67	-0.41	-0.2	0.21 0.21 0.41	0.59	0.56	0	
EXISTING SURFACE LEVEL	111.99		112.01	111.97	111.87	111.5	111.28	111.35	110.68	
OFFSET FROM CENTRELINE	-11.62		8 1-	-5	-1.5	0 0 1.5	2	6.5	13.91	

CH	4160
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REVISION	AMENDMENT	APPROVED	DATE
		1	





Private Bag 6019 Napier 4142 New Zealand

TRANSPORT

1:250 [A1], 1:500 [A3]		A1
DRAWN	DESIGNED	APPROVED
P. BIRSE	A. LEWIS	-
DRAWING VERIFIED	DESIGN VERIFIED	APPROVED DATE
A. LEWIS	J. TAYLOR	_


FOR INFORMATION

with a
REALIGNMENT
SH2 R.P. 577/11.600-592/2.500 WAIKARE GORGE
WAKA KOTAHI NZ TRANSPORT AGENCY
PROJECT


TLE	
ROSS SECTIONS	
HEETS 1 TO 43	

WSP PROJECT NO 2-S5416.01

REVISION SHEET NO. 0185 WGR-DES-GEM-00-DRG

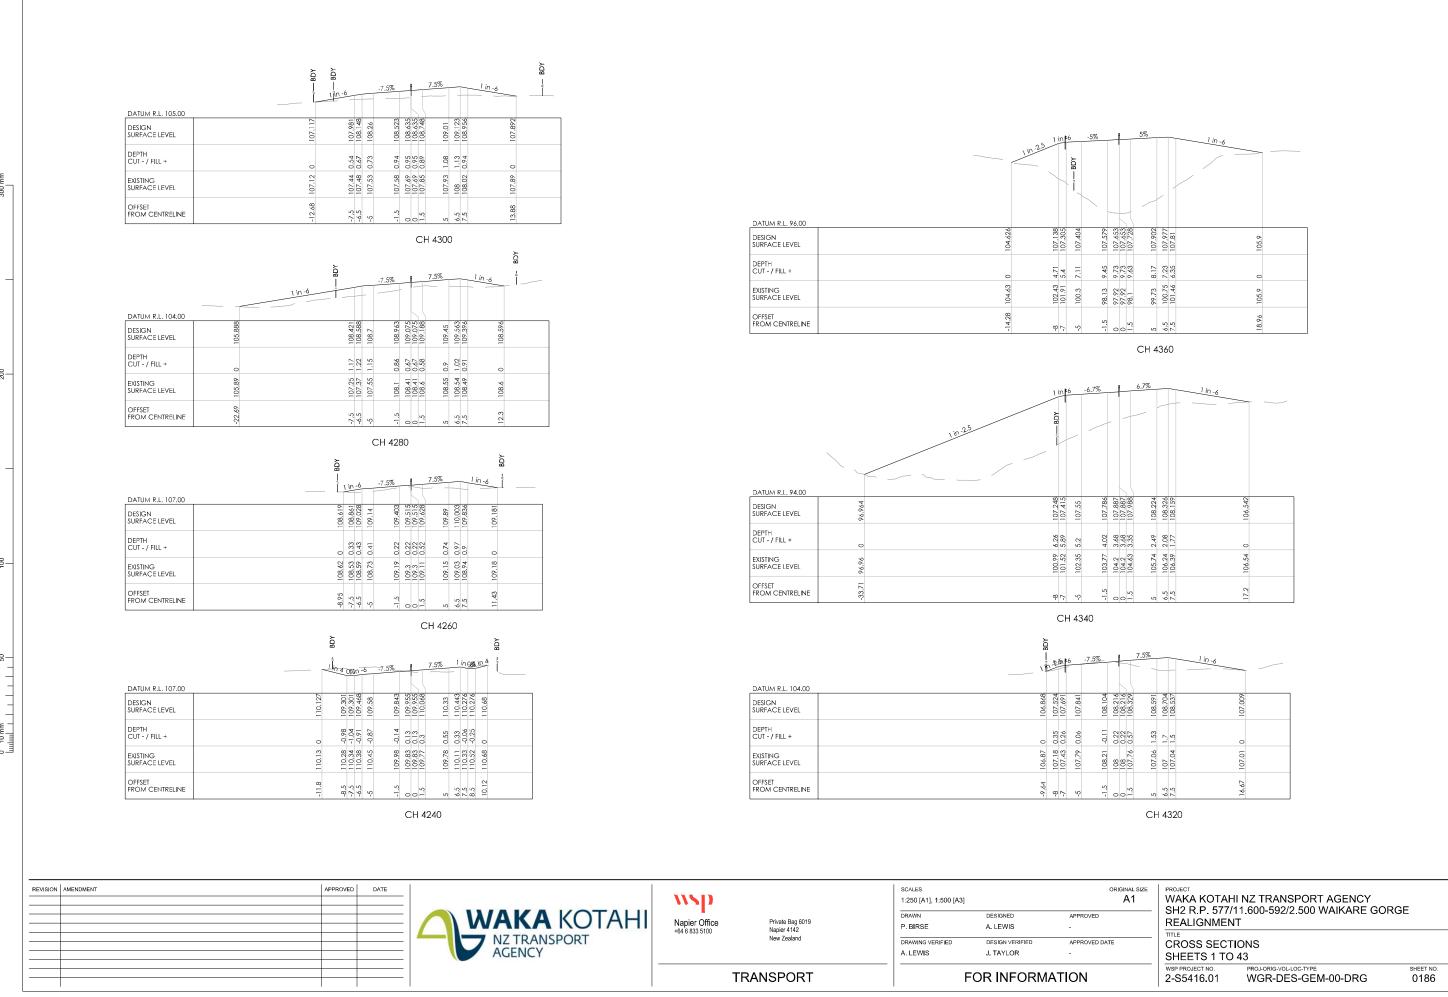

REVISION A

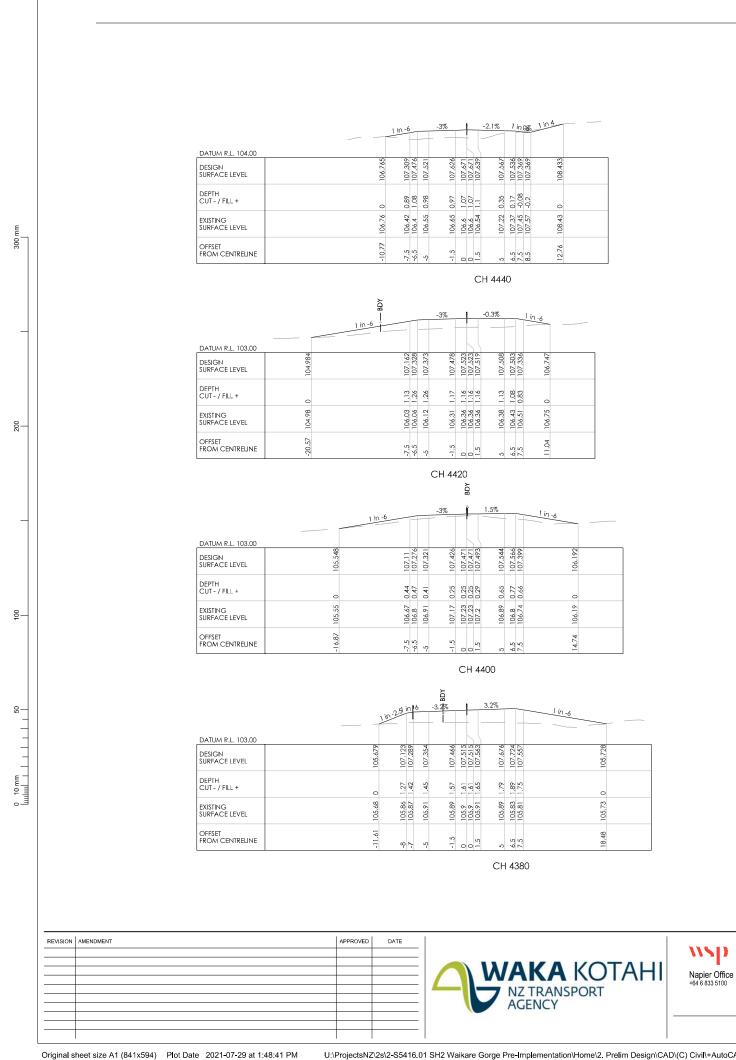


		1 In	4	)(%an	-6	-1.1%	-		-3%	1 j	n 0%.		1 in 4	
DATUM R.L. 107.00	_	9		90	٥	00	2	0	40		20	<u></u>		
DESIGN SURFACE LEVEL	110.761	110.12	108.87	109.042	109.059	109.098	= :	109.07	108.965	108.92	108.753	110.003	112.357	
DEPTH CUT - / FILL +	0	0.72		-2.21	-2.23	-2.47	-2.56	-2.58	-2.96	-3.07	-3.2/	-2.18	0	
EXISTING SURFACE LEVEL	110.76	110.84	111.02	111.09	111.29	111.57	111.67	111.75	111.92	= :	112.04	112.18	112.36	
OFFSET FROM CENTRELINE	-16.04	-13.5	8.5	-7.5	47	1.5	0	1.5	2	6.5	6.5	13.5	22.92	

CH 4520 -3% 1 in 0%% DATUM R.L. 106.00 DESIGN SURFACE LEVEL DEPTH CUT - / FILL + existing Surface level OFFSET FROM CENTRELINE

1 in agan-6 -3% -3% DATUM R.L. 106.00 DESIGN SURFACE LEVEL DEPTH CUT - / FILL + -0.27 -0.32 -0.32 -0.66 108.57 108.57 108.57 108.86 EXISTING SURFACE LEVEL OFFSET FROM CENTRELINE


CH 4500

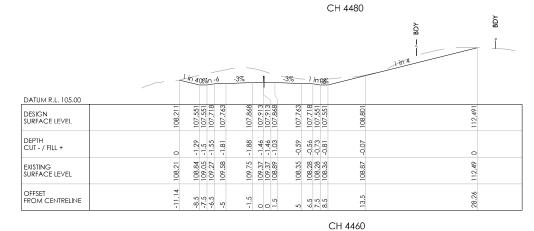

WAKA KOTAHI NZ TRANSPORT AGENCY SH2 R.P. 577/11.600-592/2.500 WAIKARE GORGE REALIGNMENT ORIGINAL SIZE SCALES 1:250 [A1], 1:500 [A3] Private Bag 6019 Napier 4142 New Zealand P. BIRSE A. LEWIS CROSS SECTIONS SHEETS 1 TO 43 DRAWING VERIFIED A. LEWIS J. TAYLOR **TRANSPORT** FOR INFORMATION 2-S5416.01 WGR-DES-GEM-00-DRG

REVISION A

SHEET NO. 0187

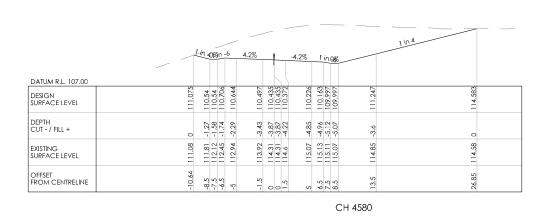

				_		_						1 in 4	
		ing	Man-	-6	2.4%	-		-3%	1	in 0%.			
DATUM R.L. 107.00						Ì							
DESIGN SURFACE LEVEL	110.413	109.985	109.985	110.116	110.031	109,995	109.995	109.845	109.8	109.633	110.883	<u> </u>	770.4
DEPTH CUT - / FILL +	0		-1.14	-1.69	-2.54	-2.8	-2.8	-3.37	3.5	-3.69	-2.69	c	
EXISTING SURFACE LEVEL	110,41	110.85	111.38	111.8	112.57	12	112.79	113.21	_	113.33	113.57	5	777
OFFSET FROM CENTRELINE	-10.21	-8.5	-7.5	5	-1.5	0	0 1.5	ro.		7.5	13.5	20,000	3.07

		<u> </u>	in 4	0 <b>%</b> an -	6	0.6%		-3%	6	1 ij	n 0%		1 in 4	
DATUM R.L. 107.00														
DESIGN SURFACE LEVEL	111.66	110.68	109.43	109.43	109.587	109.565	109.555	109.51	109.405	88	109.193	110.443	113 705	
DEPTH CUT - / FILL +	0	5.	-3.24	-3.33	-3.32	-3.5	3.56	-3.66	-3.95	-4.06	-4.28	3.11	c	
EXISTING SURFACE LEVEL	111.66	112.18	112.67	112.76	112.91	113.06	113.11	mi mi	113.35	113.42	113.42	113.56	13 73	
OFFSET FROM CENTRELINE	-17.42	-13.5	-8.5	-7.5	-5	-1.5	00	ç.			8.5	13.5	× 43	

CH 4540

REVISION	AMENDMENT	APPROVED	DATE

Original sheet size A1 (841x594) Plot Date 2021-07-29 at 1:48:52 PM





Private Bag 6019 Napier 4142 New Zealand

TRANSPORT

SCALES 1:250 [A1], 1:500 [A3] ORIGINAL SIZE P. BIRSE A. LEWIS DRAWING VERIFIED A. LEWIS J. TAYLOR


FOR INFORMATION

WAKA KOTAHI NZ TRANSPORT AGENCY SH2 R.P. 577/11.600-592/2.500 WAIKARE GORGE REALIGNMENT

CROSS SECTIONS SHEETS 1 TO 43

SHEET NO. 0188 REVISION WSP PROJECT NO. 2-S5416.01 WGR-DES-GEM-00-DRG

U:\ProjectsNZ\2s\2-S5416.01 SH2 Waikare Gorge Pre-Implementation\Home\2. Prelim Design\CAD\(C) Civil\+AutoCAD\2-S5416.01\_C(CS)-C(CS).dwg 0188A

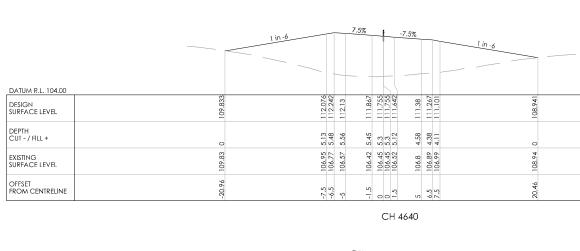

		1 in-6			7.5%		-7.5%		l in -6	
DATUM R.L. 104.00						- 1,	)			
DESIGN SURFACE LEVEL	107.973		111.636	111.802	111.427	111.315	110.94	110.827		
DEPTH CUT - / FILL +	0		5.57	5.67		3.78	2.19	1.81		
EXISTING SURFACE LEVEL	76.701		106.07	106.13	107.13	107.54	108.75	109.02	110.04	
OFFSET FROM CENTRELINE	29.47		7.5	5.5	1.5	5		5.5	1.2	

DATUM R.L. 103.00		1 in-6	-		5.9%	+	-5.9%	Ti	08%	1 in 4		. —
DESIGN SURFACE LEVEL	106.559		111.094	=	110.964	110.875	110.578	110.489	110.322	111.572	113.714	
DEPTH CUT - / FILL +	0		2.6	2.27	1.39	0.96	0.54	0.88	-1.42	-1.06	0	
EXISTING SURFACE LEVEL	106.56		108.5	108.91	109.58	109.91	110.24		111.74	112.63	113.71	
OFFSET FROM CENTRELINE	-34,71		-7.5	ζ.	-1.5	00	- s	6.5	8.5	13.5	22.07	

CH 4600

REVISION	AMENDMENT	APPROVED	DATE

Original sheet size A1 (841x594) Plot Date 2021-07-29 at 1:49:04 PM



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Private Bag 6019 Napier 4142 New Zealand

TRANSPORT

FOR INFORMATION

WAKA KOTAHI NZ TRANSPORT AGENCY SH2 R.P. 577/11.600-592/2.500 WAIKARE GORGE REALIGNMENT


CROSS SECTIONS SHEETS 1 TO 43


 WSP PROJECT NO.
 PROJ-ORIG-VOL-LOC-TYPE
 SHEET NO.

 2-S5416.01
 WGR-DES-GEM-00-DRG
 0189

REVISION

U:\ProjectsNZ\2s\2-S5416.01 SH2 Waikare Gorge Pre-Implementation\Home\2. Prelim Design\CAD\(C) Civil\+AutoCAD\2-S5416.01\_C(CS)-C(CS).dwg 0189A

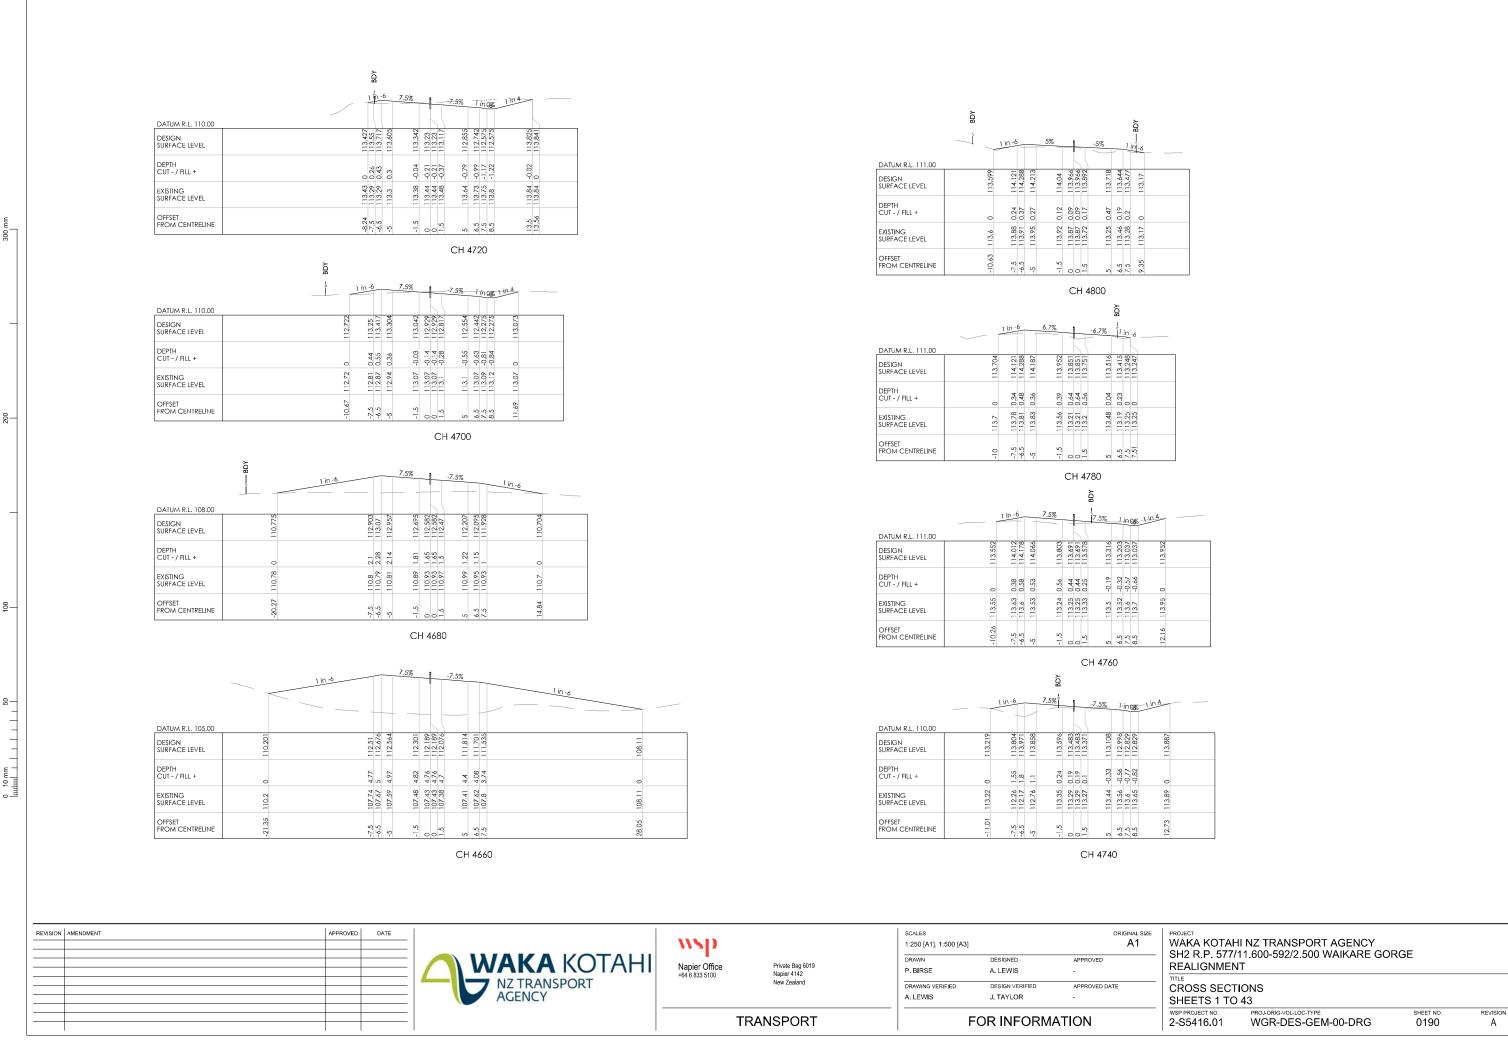

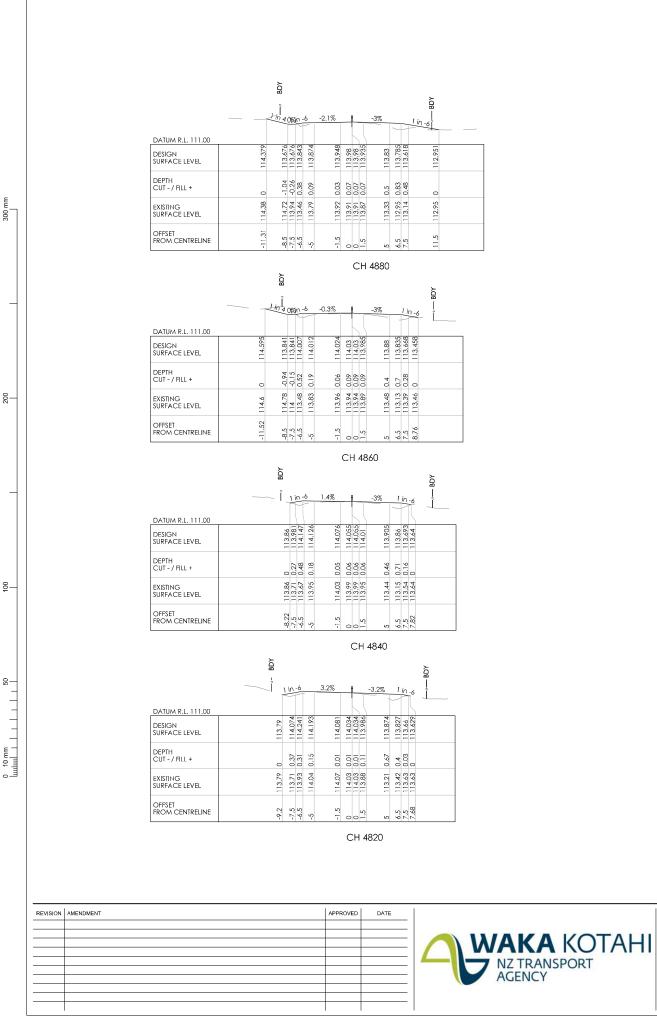

	BDY											ВД	
			OPar	1-6	_	-3%		-	-3%		in 0	<u>34</u>	
DATUM R.L. 111.00			1	\				\\					
DESIGN SURFACE LEVEL		113.443	113.433	113.6	113.645	113.75	113.795	113.795	113.645	113.6	113.433	113.464	
DEPTH CUT - / FILL +		0	-0.02	-0.15	-0.16	-0.09	0	0.04	0.47	-0.29	-0.29	0.04	
EXISTING SURFACE LEVEL		113.44	113.45	113.75	113.8	113.84	113.79	113.79	113.18	113.89	113.72	113.46	
OFFSET FROM CENTRELINE		-8.54	-8.5	-6.5	s,	5,1-	0	0	ις	6.5	7.5	8.62	
								СН	4960				
	BDY											BDY	

				CH 4960	
	BDY				BDY
	ئ	1 in -6	-3%	-3%	1 in -6
DATUM R.L. 111.00		1			
DESIGN SURFACE LEVEL		113.47 113.47 113.637 113.682	113.787	113.787	113.637 113.334 113.334
DEPTH CUT - / FILL +		0 -0.01 -0.05 -0.12	-0.08	0.02 0.02 0.53	0.35
EXISTING SURFACE LEVEL		113.47 113.48 113.69 113.8	113.87	113.83	112.79
OFFSET FROM CENTRELINE		-7.53 -7.5 -6.5 -5	-1.5	5.5	6.5 8.32

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		₽D								BDY	
		1 in-6		-3%	+	_	-3%	_	1	in -6	
DATUM R.L. 111.00						1					
DESIGN SURFACE LEVEL	112.953	113.518	113.73	113.835	113.88	113.835	113.73	113.685	_	113.104	
DEPTH CUT - / FILL +	0	0.11	-0.04	P	0.08	0.08	0.99	0.51	0.2	0	
EXISTING SURFACE LEVEL	112.95	113.41	113.77	113.84	113.8	113.75	112.74	113.18		113.1	
OFFSET FROM CENTRELINE	-10.89	-7.5 -6.5	-5	<u>.</u> 3.	0	7.	ю	6.5	7.5	86.6	

					(	CH.	4920				
	BDY									BDY	
	 Ĭ	1 in	-6	-3%	_	-	-3%	_		1 in -6	
DATUM R.L. 111.00		\	\			1					
DESIGN SURFACE LEVEL	113.458	113.568	113.78	113.885	113.93	113.93	113.78	113,735	113.568	113.011	
DEPTH CUT - / FILL +	0	0.26	0.05	0.02	0.11	0.13	0.44	0.79	0.39	0	
EXISTING SURFACE LEVEL	113.46	113.31	113.73	113.86	_	113.82	113.34	112.95	113.18	113.01	
OFFSET FROM CENTRELINE	-8.16	-7.5	5 5	-1.5	0	0.1.5	22		7.5	10.84	
·						(	CH 49	00			

TRANSPORT

wsp		SCALES 1:250 [A1], 1:500 [A3]		ORIGINAL SIZE A1
Napier Office	Private Bag 6019 Napier 4142	DRAWN P. BIRSE	DESIGNED A. LEWIS	APPROVED -
*04 0 000 0100	New Zealand	DRAWING VERIFIED A. LEWIS	DEŞIGN VERIFIED J. TAYLOR	APPROVED DATE

FOR INFORMATION

	HI NZ TRANSPORT AGENCY 11.600-592/2.500 WAIKARE GO IT	RGE	
CROSS SECT SHEETS 1 TO			
WSP PROJECT NO. 2-S5416.01	PROJ-ORIG-VOL-LOC-TYPE WGR-DES-GEM-00-DRG	SHEET NO. 0191	REVISION A

	ВД	BD∀
	1 in-6	-3% 1 in 0% 1 in 4
DATUM R.L. 111.00  DESIGN SURFACE LEVEL	13.432 13.599 13.644	113.749 113.794 113.794 113.644 113.432 113.432
DEPTH CUT - / FILL +	0 -0.23 1 -0.15 1	0 0 1 0 0 1 0 0 0 1 0 0 0 0 0 0 0 0 0 0
EXISTING SURFACE LEVEL	113.43 113.66 113.74	113.84 113.79 113.79 114.17 114.65 114.65 114.45
OFFSET FROM CENTRELINE	-8.1 -7.5 -6.5 -5	-1.5 0 0 1.5 1.5 8.5 8.5

	CH 4988				
	ВОУ	BDY			
	1 in-6	-3% line 1 in 4			
DATUM R.L. 111.00					
DESIGN SURFACE LEVEL	113.431 113.431 113.598				
DEPTH CUT - / FILL +	0 -0.23 -0.16	0 0 0 0 0 0 0 0 0 0 0 0 0 0 0 0 0 0 0 0			
EXISTING SURFACE LEVEL	113.43	113.84 113.79 113.79 1113.79 114.03 114.09 114.27			
OFFSET FROM CENTRELINE	-8.31 -7.5 -6.5	11.5 0 0 1.5 5.5 6.5 8.5 8.5			

CH 4980

REVISION	AMENDMENT	APPROVED	DATE
		1	

Original sheet size A1 (841x594) Plot Date 2021-07-29 at 1:49:39 PM





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P. BIRSE A. LEWIS DRAWING VERIFIED A. LEWIS J. TAYLOR

FOR INFORMATION

SCALES 1:250 [A1], 1:500 [A3]

ORIGINAL SIZE

WAKA KOTAHI NZ TRANSPORT AGENCY SH2 R.P. 577/11.600-592/2.500 WAIKARE GORGE REALIGNMENT

CROSS SECTIONS SHEETS 1 TO 43

SHEET NO. 0192 REVISION A WSP PROJECT NO. 2-S5416.01 WGR-DES-GEM-00-DRG

# Appendix B

Historical aerial image review



# Historical aerial image review notes

- The following images (from Page 2 onwards) were sourced by GHD from Retrolens<sup>1</sup>, and LINZ<sup>2</sup>.
- Images from the following years were selected for this review due to their availability and clarity: 1945, 1962, 1973, 1983, 1996, 2003, 2010, 2015, and 2020.
- Clear aerial images from this year (2021) were not available for review.
- The 1996 aerial image depicts only the southern section of the Alignment (south of the Wakari River). There were no other images available for the year of 1996 that depicted the remainder of the Alignment.
- The approximate location of the Alignment is shown as a red line in the images. The red line is an indication of location only and does not represent the width of the Alignment, nor does it represent any soil disturbance areas (cut / fill).
- Except for 1996 (for which there are three), each year is split into five separate images which allows the Alignment and surrounding area to be viewed in greater detail. Each image has its own page in this review and there are 43 separate images in total.
- For each year, the first image captures the area where the northern tie in works are proposed. Each image from here moves further south along the Alignment.
- There are no north arrows or scale indicators on the images. The top of each image is approximately north facing, and the scale of each image is unknown.




<sup>&</sup>lt;sup>1</sup> www.retrolens.co.nz


<sup>&</sup>lt;sup>2</sup> www.data.linz.govt.nz





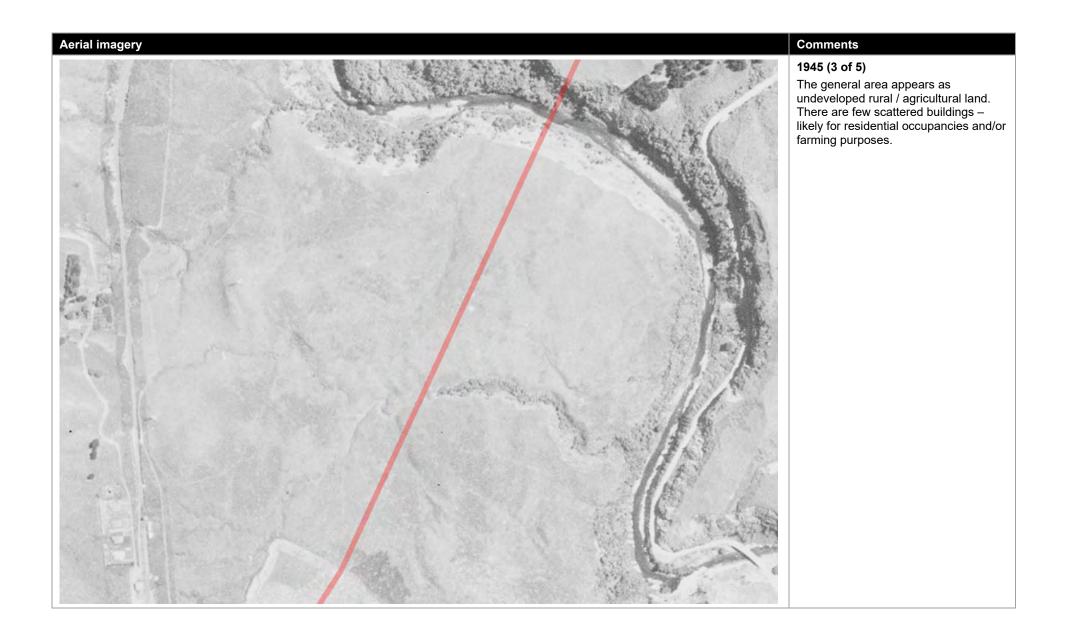





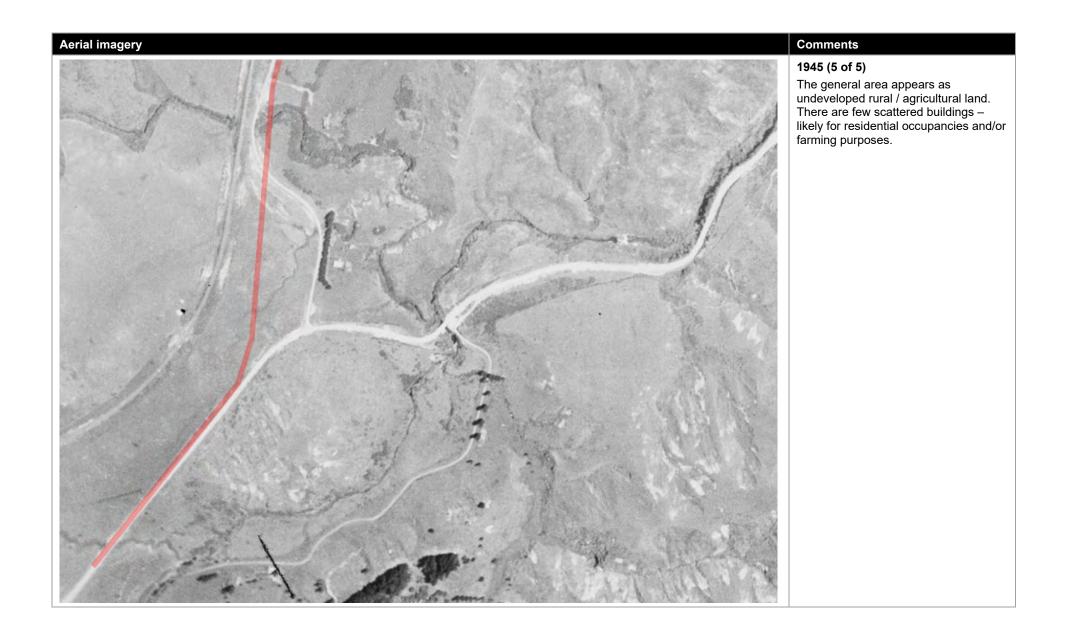





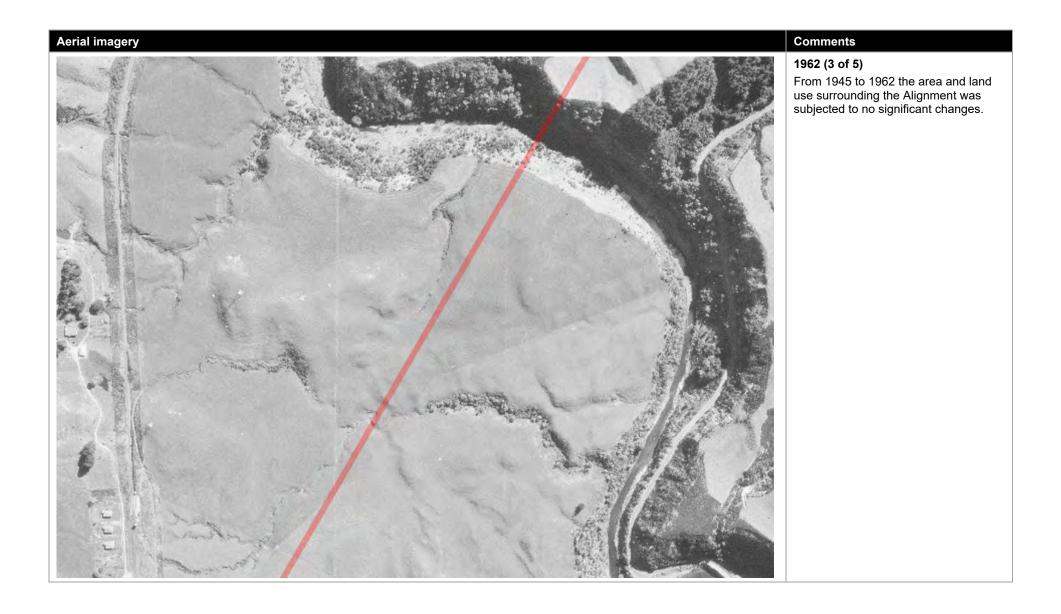

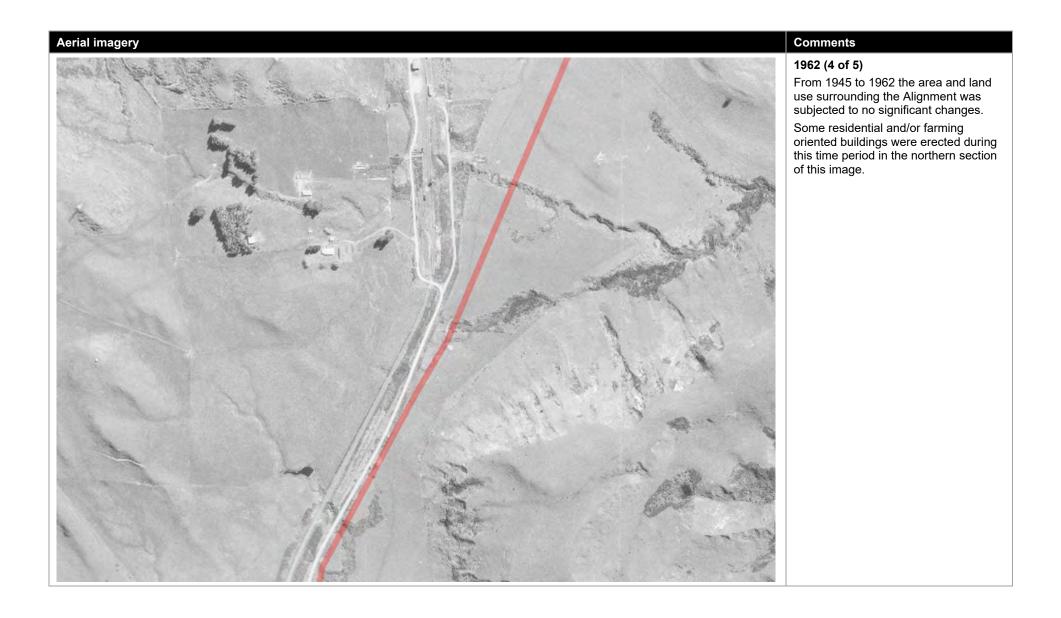








## 1973 (2 of 5)

From 1962 to 1973 the area and land use surrounding the Alignment was subjected to no significant changes.

What appears to be a farm shed situated east of the Alignment (near the change in direction) was erected during this time period.

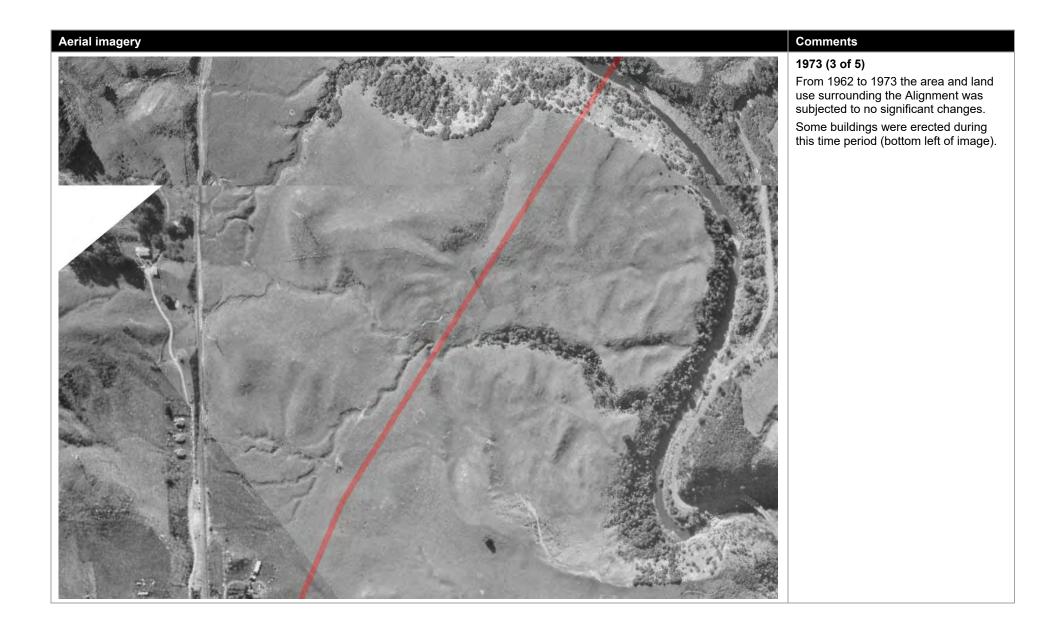




## 1973 (4 of 5)

From 1962 to 1973 the area and land use surrounding the Alignment was subjected to no significant changes. Some buildings were erected during this time period (northern section of image).







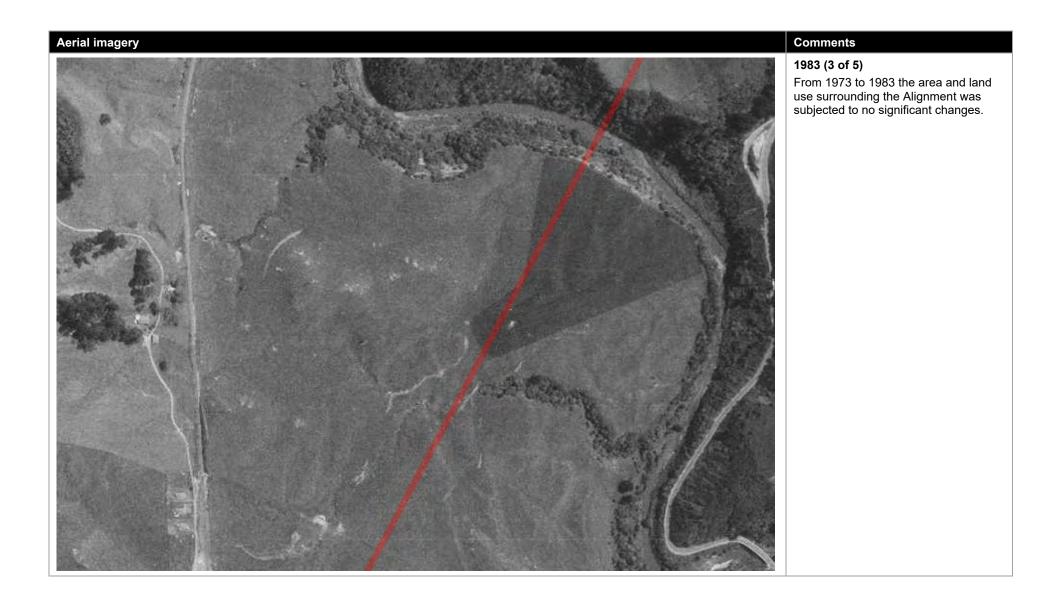







## 1983 (5 of 5)

From 1973 to 1983 the area and land use surrounding the Alignment was subjected to no significant changes.

One building was erected during this time period (bottom left of image).

Some buildings were demolished during this time period including some tree removal / land clearance (middle right of image).

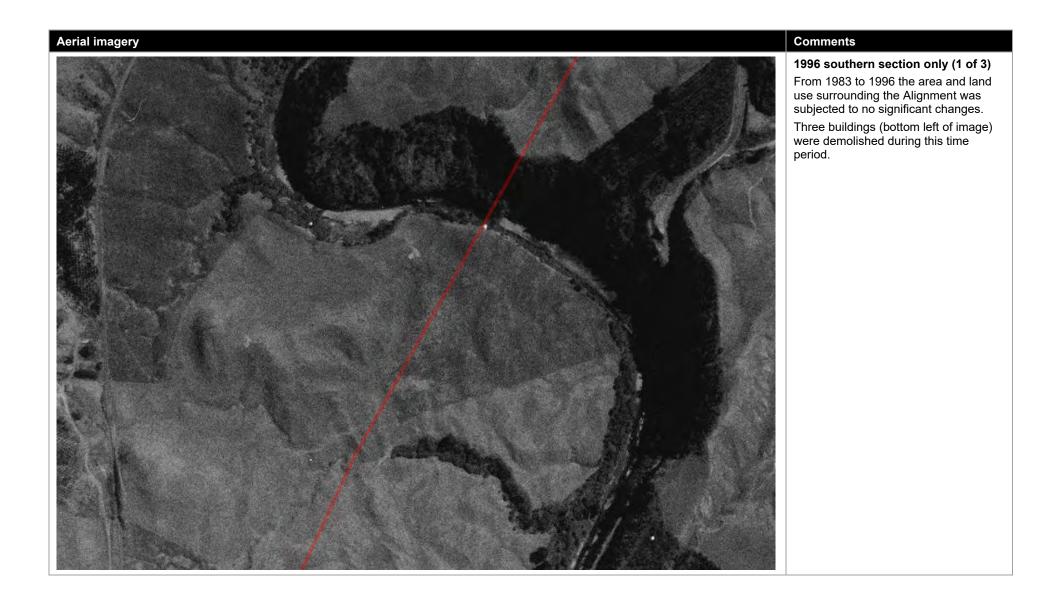

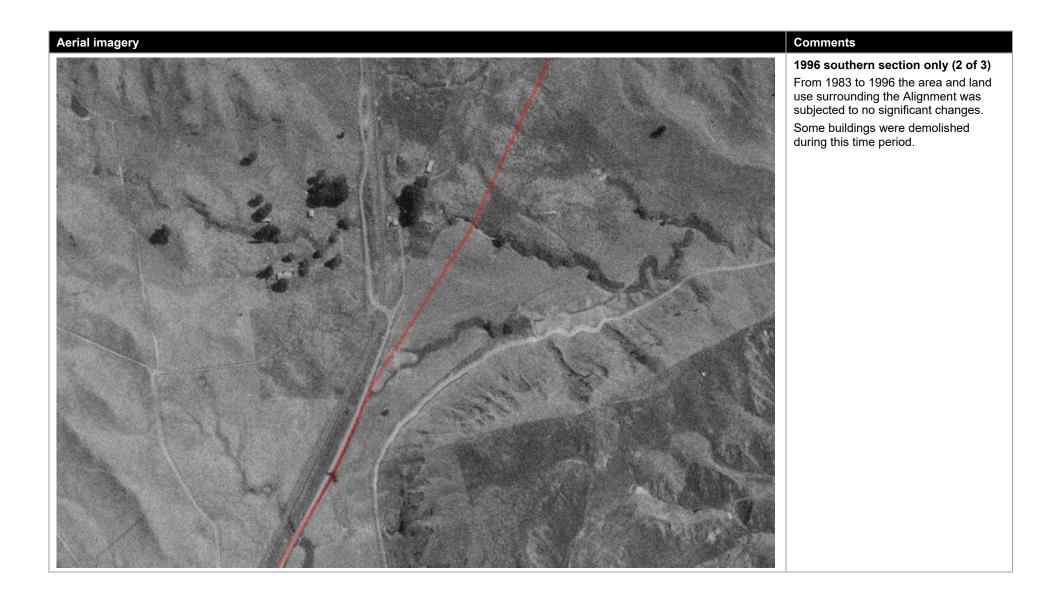




## 1996 southern section only (3 of 3)


From 1983 to 1996 the area and land use surrounding the Alignment was subjected to no significant changes.


A milking shed was erected during this time period (middle left of image). North of the milking shed two man made storage ponds have appeared.

Trees (potentially for forestry) have been planted in the bottom right of the image.

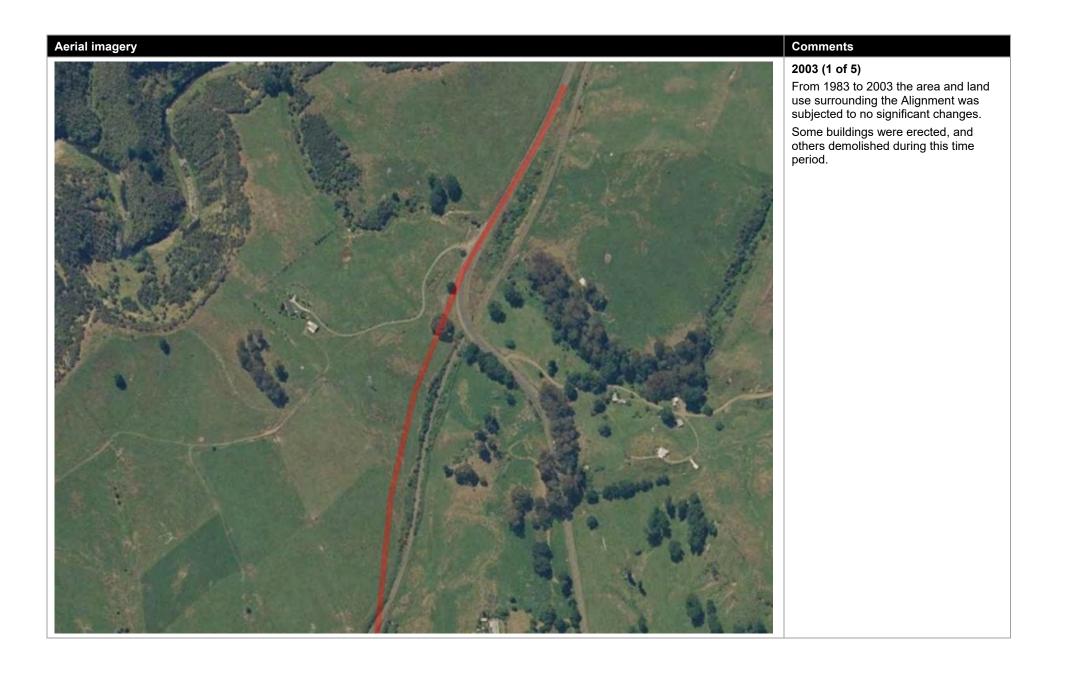



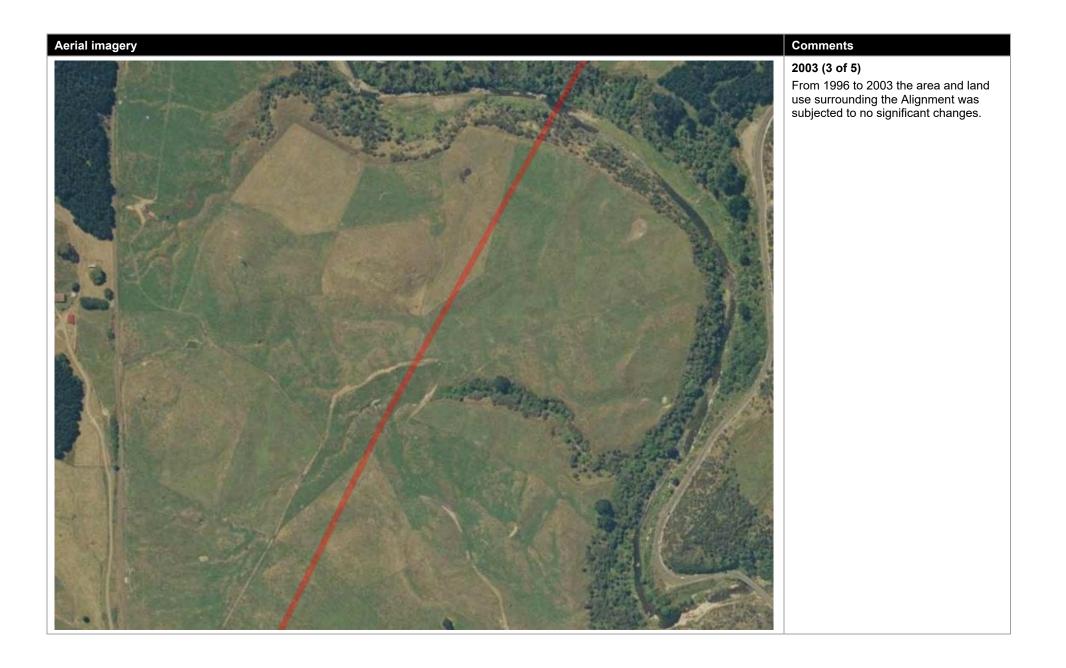

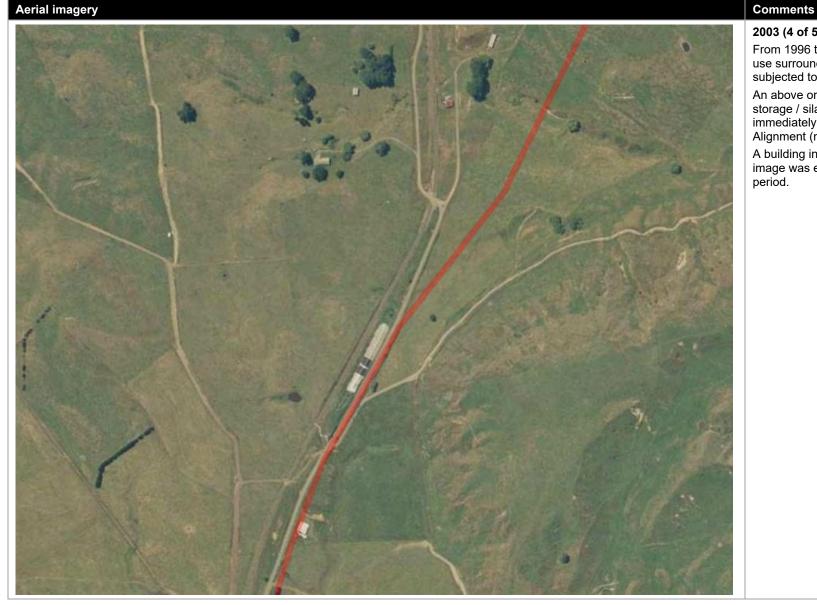

### 2003 (4 of 5)

From 1996 to 2003 the area and land use surrounding the Alignment was subjected to no significant changes.

An above or below ground dumping / storage / silage area appeared immediately adjacent the railway line / Alignment (middle of image).

A building in the middle bottom of the image was erected during this time period.



### 2003 (5 of 5)

From 1996 to 2003 the area and land use surrounding the Alignment was subjected to no significant changes. A shed was erected to the left of the milking shed during this time period. Some buildings were demolished during this time period.



### 2010 (1 of 5)

From 2003 to 2010 the area and land use surrounding the Alignment was subjected to no significant changes. Some buildings were erected, and others demolished during this time period (middle right of image).






### 2010 (3 of 5)

From 2003 to 2010 the area and land use surrounding the Alignment was subjected to no significant changes.

Many man-made water ponds / storage reservoirs appeared during this time period.

A milking shed including a few other sheds were erected during this time period (bottom left of image).

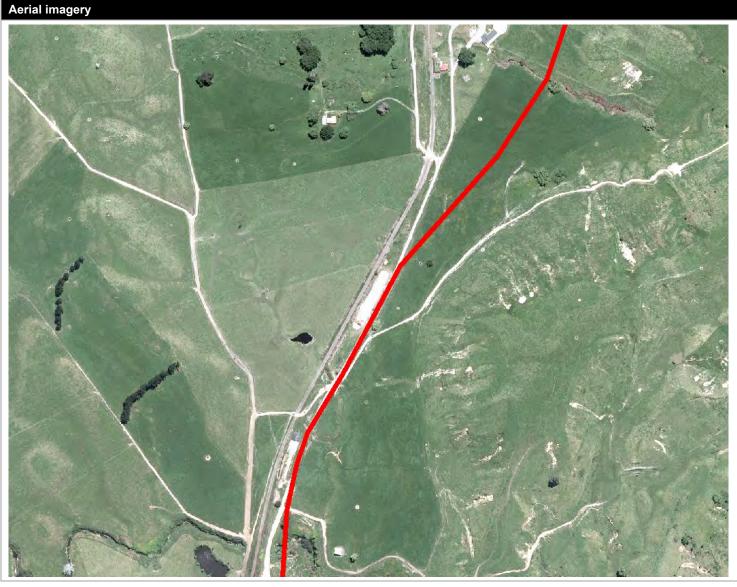


### 2010 (4 of 5)


From 2003 to 2010 the area and land use surrounding the Alignment was subjected to no significant changes.

A secondary above or below ground dumping / storage / silage area appeared immediately adjacent the railway line / Alignment, south of the first one (middle bottom of image).

A building in the middle bottom of the image was demolished during this time period.

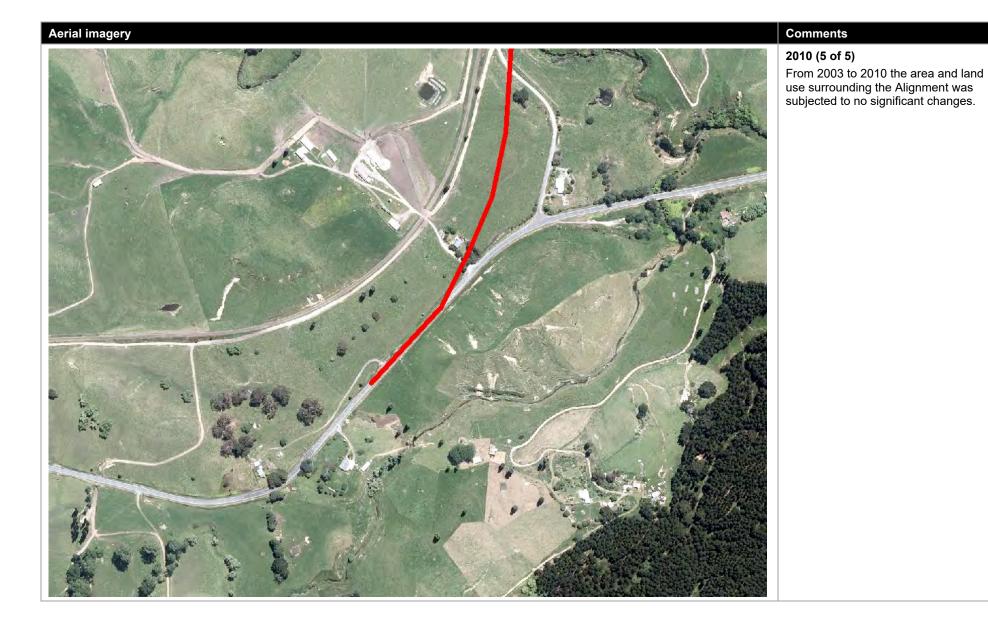



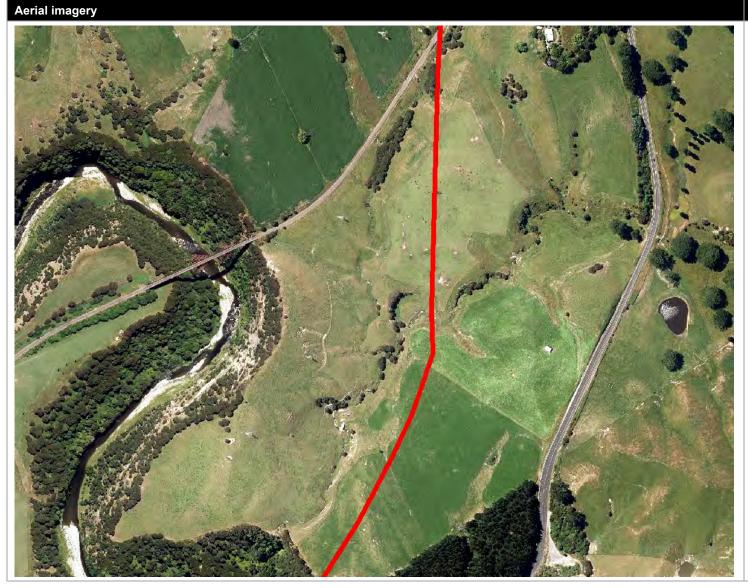

### 2015 (2 of 5)


From 2010 to 2015 the area and land use surrounding the Alignment was subjected to no significant changes.





### 2015 (3 of 5)

From 2010 to 2015 the area and land use surrounding the Alignment was subjected to no significant changes.


An above ground silage area appeared immediately adjacent the Alignment to the northeast of the milking shed (middle bottom of image).

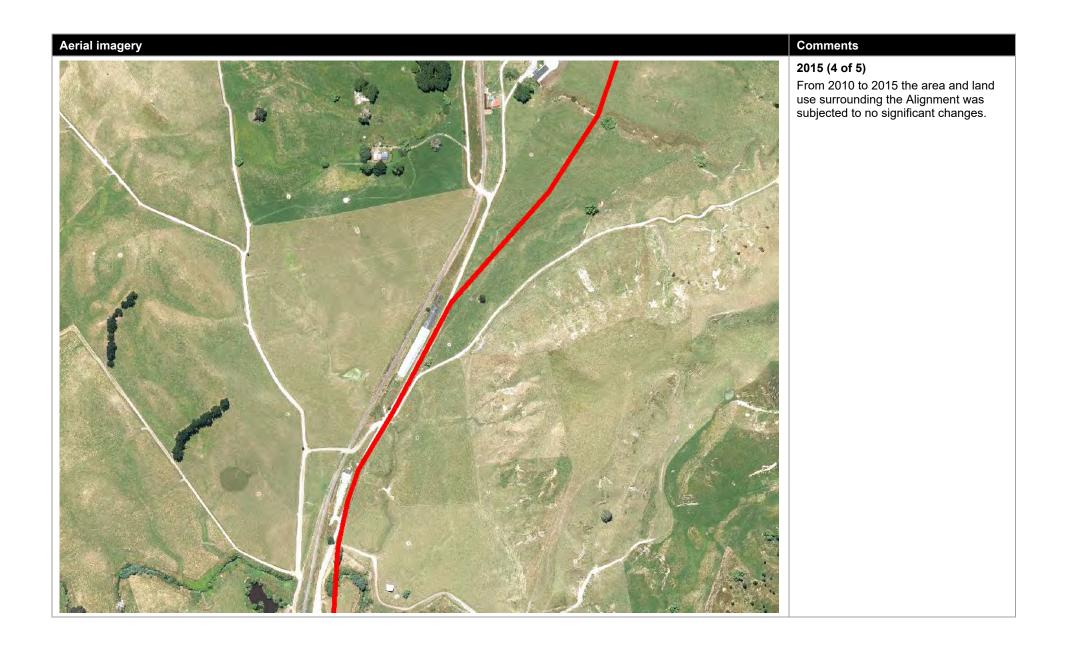

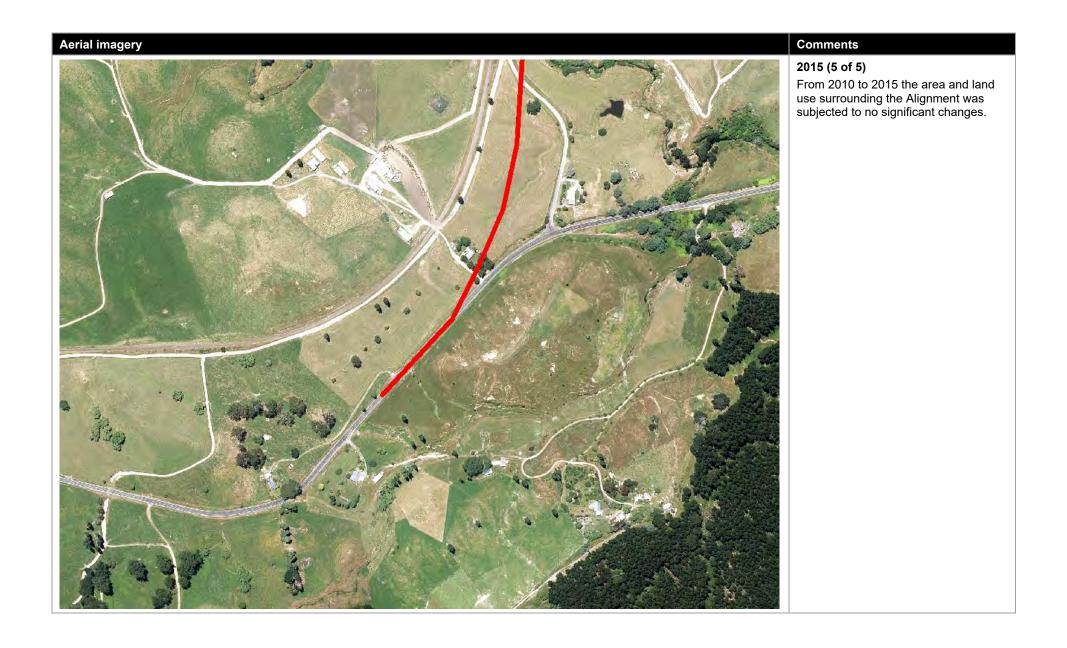

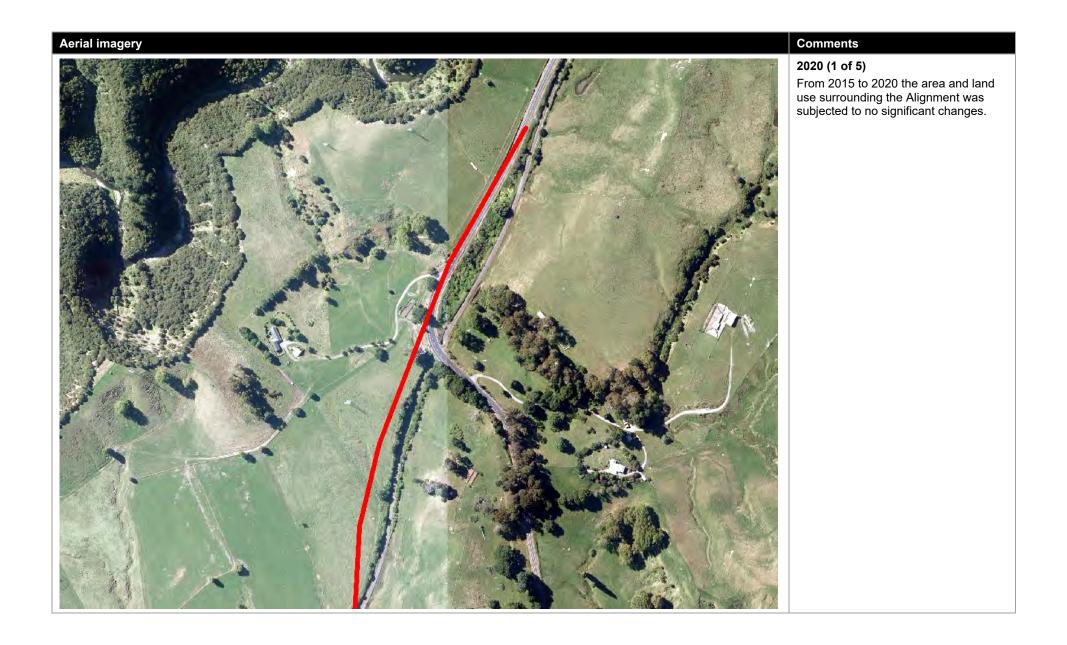



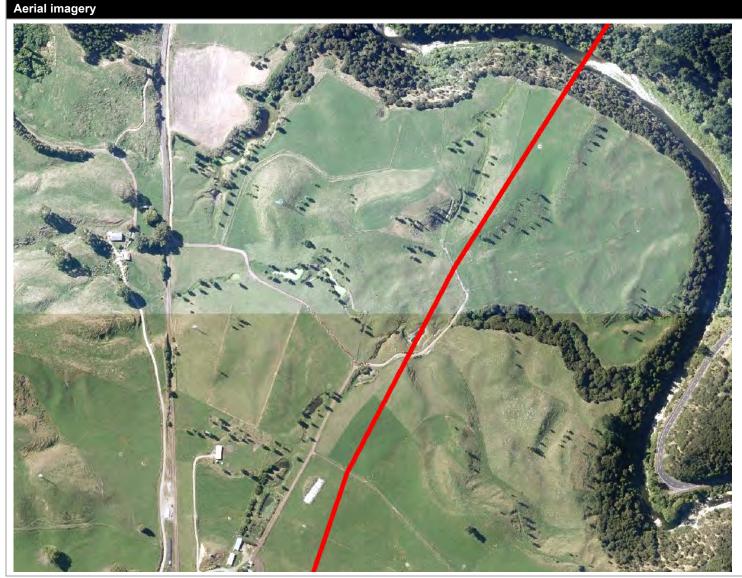


### 2020 (3 of 5)


From 2015 to 2020 the area and land use surrounding the Alignment was subjected to no significant changes.

A building was erected east of the railway line and north of the milking shed (bottom left of image).

A soil stockpile has appeared immediately north of the milking shed (bottom left of image).

Some stockpiles have appeared immediately west of the railway line (bottom left of image).

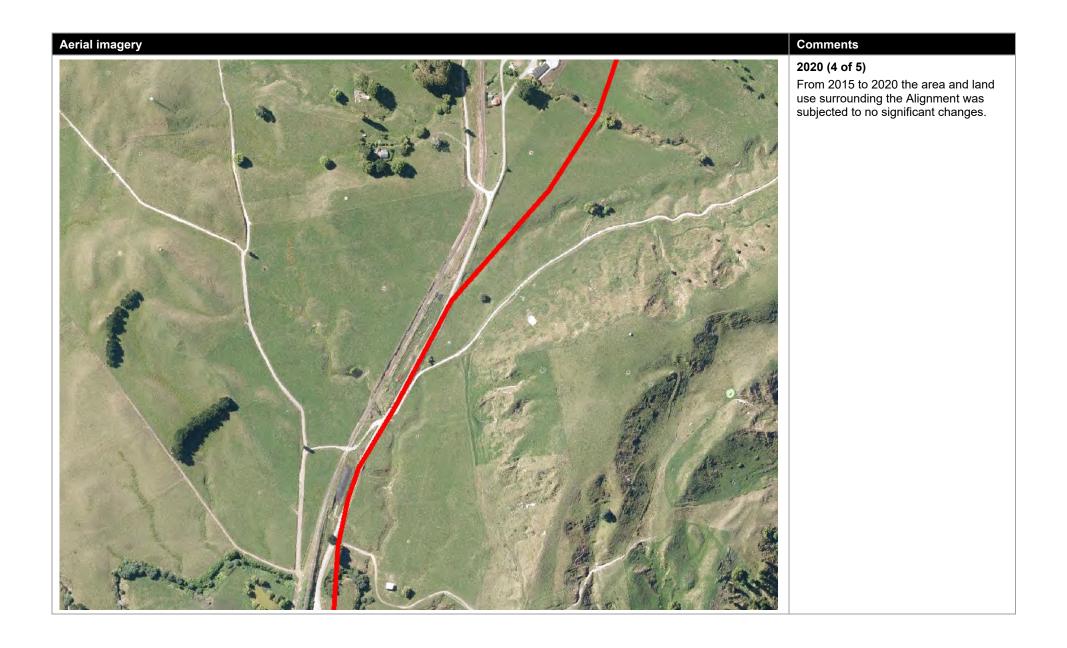

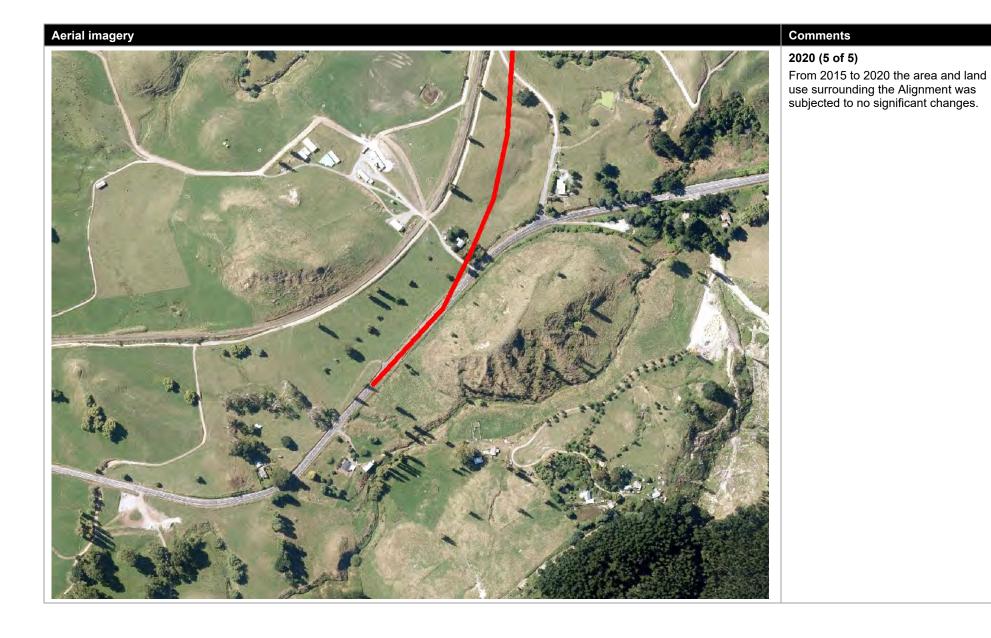

# Appendix C

**Council provided information** 

### **Max van Stom**

**From:** contaminated.land <contaminated.land@hbrc.govt.nz>

**Sent:** Wednesday, 15 September 2021 12:40

**To:** Max van Stom

**Subject:** RE: Waikare Gorge Contamination Report Request

Attachments: Register Statement - Waikare Gorge.pdf; Consent Document-AUTH-124776-01

\_AUTH-124777-01\_.pdf; DP170556L - 20180529 - Consent Document.pdf; Register Statement -

5257 State Highway 2\_ Putorino\_ Hastings.pdf

Hi Max,

Please see attached the Selected Land Use Register Statement for the properties located within the Waikare Gorge project as per your request. I have assessed all historical imagery and associated property files here at HBRC, and we do not have any information/evidence that would indicate potentially contaminating activities occurring on the parcels included in this report. I have listed associated resource consents within the report and attached a copy of the consent documents. Due to the age of the bore permits unfortunately I haven't been able to find copies of the permits.

The property at 5257 State Highway 2 is included on our HAIL database as I found evidence of fuel storage tanks located at the site but they have since been removed.

The invoice relating to this investigation will be sent out in due course.

Should you have any further questions, please don't hesitate to get in touch.

Kind regards,



### Irena Mikolic

Environmental Compliance Officer 0800 108 838 | 06 835 9200

Hawke's Bay Regional Council | Te Kaunihera ā-rohe o Te Matau a Māui 159 Dalton Street, Napier 4110 | <u>hbrc.govt.nz</u>

Enhancing Our Environment Together | Te Whakapakari Tahi I To Tatau Taiao









Let us know how we're doing, give your feedback here.

This communication, including any attachments, is confidential. Refer to the <u>disclaimer</u> on our website.



14th September 2021

GHD C/- Max van Stom PO Box 6543 Victoria Street West AUCKLAND 1142

Dear Max,

### PROPERTY ENQUIRY: SELECTED LAND USE REGISTER (SLUR) STATEMENT

Thank you for submitting your property enquiry in relation to our Selected Land Use Register which holds information about sites that have been used, or are currently used for activities which have the potential to have caused contamination.

The Selected Land Use Register statement provided below indicates the location of the land parcel(s) you enquired about. This provides information relating any listed sites within a radius of this land as specified in the statement.

Please note that if a property is not currently entered on the Register, it does not mean that an activity with the potential to cause contamination has never occurred, or is not currently occurring there. The Register is not complete and new sites are regularly being added as we receive information and conduct our own investigations into current and historic land uses.

The Selected Land Use Register only contains information held by Hawkes Bay Regional Council in relation to contaminated or potentially contaminated land; other information relevant to potential contamination may be held in other files (for example consent and enforcement files).

If your enquiry relates to a farm property, please note that many current and past activities undertaken on farms may not be listed on the Register. Activities such as the storage, formulation and disposal of pesticides, offal pits, foot rot troughs, animal dips and underground or above ground fuel tanks have the potential to cause contamination.

Please contact the Hawkes Bay Regional Council hazardous substances team if you wish to discuss the contents of the Register Statement, or if you require additional information.

Yours sincerely

IRENA MIKOLIC

**ENVIRONMENTAL OFFICER COMPLIANCE** 

**REGULATION GROUP - HAZARDOUS SUBSTANCES TEAM** 

Email: contaminated.land@hbrc.govt.nz



# **Hawkes Bay Regional Council Selected Land Use Register Statement**

Date requested: 10/09/2021 Date generated: 14/09/2021

### **PARCEL ENQUIRY REFERENCE:**

Property Address(s):	5257 State Highway 2, Putorino, Hastings		
Legal Description(s):	Part Section 37 Block II, Section 51 Block II Moeangiangi SD		
Parcel ID(s):	4235170, 4228513		
Valuation	0953009300		
Number(s):			





The above map outlines the specific parcel(s) or area(s) where contaminated land information has been requested

### SITES WITHIN AREA OF ENQUIRY:

### **Summary of sites:**

Site ID	Site Name	Location	HAIL activity(s)	Category	Sub-Category
SLS-11355	5257 State Highway 2, Putorino, Hastings	5257 State Highway 2, Putorino, Hastings	F4	Verified HAIL	Risk Not Quantified

Please note that the above table represents a summary of sites and HAIL within the area of enquiry stated above only.

### Information held about the sites on the Selected Land Use Register

Site ID:	SLS-11355
Site address:	5257 State Highway 2, Putorino, Hastings
Legal Description(s):	Part Section 37 Block II, Section 51 Block II Moeangiangi SD
Site category:	Verified HAIL
Site sub category:	Risk Not Quantified

HAIL Details:	HAIL description	Period from	Period to
F4	Motor Vehicle Workshops	1981	2002

### Site Notes:

Property files indicate that a vehicle workshop was located at this site from early 1980's which included two fuel storage tanks. The tanks (2 x 4545L) were removed in 2002. There are no reports on file confirming any investigations or sampling undertaken.

### Site Investigation(s):

There are no investigations associated with this site.

### Resource Consent(s):

There are no resource consents associated with this site.

# Photograph(s):



Photo 1: Aerial image from 1979



Photo 2: Aerial image from 1981 showing vehicle workshop

## Other Relevant Information

There is no relevant information in relation to contaminated land for this location.

### Disclaimer:

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The information is made available in good faith but the council does not warrant the accuracy or completeness of the information. Users of this Register who rely on the information provided without obtaining independent verification, do so at their own risk. Hawke's Bay Regional Council accepts no liability for any inaccuracy in or omission from the information. Any party relying on the information does so at their own risk.

The given land use category reflects the Council's understanding at the time of the date indicated for the property's assessment, which is based only on the information obtained by it and held on record at the time. The site condition or information available may have changed since the date of the Council's assessment of the property. Any person acting on the information should verify the site's condition at the time. The Council accepts no responsibility for changes to the site condition since the site was listed on the Register.

Properties listed on the Register include properties where potentially contaminating activities are suspected to have occurred (Unverified HAIL sites) or are known to have occurred but no physical investigation has taken place (Not investigated sites). In both cases, the listing is not an indication of actual contamination and no reliance can or should be placed by any person as indicating the actual presence of contaminants on such sites. Further investigation is required to establish the actual presence or absence of contaminants.

The Council does not warrant a listed property's suitability for any specific purpose. The listing is based only on human health considerations. Where a site has been investigated and been listed as suitable for one of several generic uses (e.g. residential or commercial), the suitability is within the given constraints (e.g. a management plan is in place and being adhered to). Such a property may not be suitable for particular land uses within that general use (e.g. being able to grow particularly plants; different plants having a widely varying sensitivity to soil contaminants). Any person relying on a property's general suitability as demonstrating the land is suitable for a specific purpose does so at their own risk. Conversely a property listed as being hazardous to people for the given generic land use may not be hazardous for some other less sensitive land use. Independent, expert advice should be sought as to the property's suitability for a particular purpose.

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Where a property or properties have been subdivided or amalgamated since the date of listing, in the absence of information to the contrary, as a precautionary approach the Council will automatically apply the original listing to the new land parcels. Given a potentially contaminating historical activity or actual contamination may originally have had a limited extent, it is not necessarily the case that all the newly subdivided properties are in the condition implied by the listing after subdivision. Similarly, not all of a newly amalgamated property is necessarily in the condition implied by the listing. Further investigation may be necessary to determine the extent of the land actually affected.



14th September 2021

GHD C/- Max van Stom PO Box 6543 Victoria Street West AUCKLAND 1142

Dear Max,

### PROPERTY ENQUIRY: SELECTED LAND USE REGISTER (SLUR) STATEMENT

Thank you for submitting your property enquiry in relation to our Selected Land Use Register which holds information about sites that have been used, or are currently used for activities which have the potential to have caused contamination.

The Selected Land Use Register statement provided below indicates the location of the land parcel(s) you enquired about. This provides information relating any listed sites within a radius of this land as specified in the statement.

Please note that if a property is not currently entered on the Register, it does not mean that an activity with the potential to cause contamination has never occurred, or is not currently occurring there. The Register is not complete and new sites are regularly being added as we receive information and conduct our own investigations into current and historic land uses.

The Selected Land Use Register only contains information held by Hawkes Bay Regional Council in relation to contaminated or potentially contaminated land; other information relevant to potential contamination may be held in other files (for example consent and enforcement files).

If your enquiry relates to a farm property, please note that many current and past activities undertaken on farms may not be listed on the Register. Activities such as the storage, formulation and disposal of pesticides, offal pits, foot rot troughs, animal dips and underground or above ground fuel tanks have the potential to cause contamination.

Please contact the Hawkes Bay Regional Council hazardous substances team if you wish to discuss the contents of the Register Statement, or if you require additional information.

Yours sincerely

IRENA MIKOLIC

**ENVIRONMENTAL OFFICER COMPLIANCE** 

**REGULATION GROUP - HAZARDOUS SUBSTANCES TEAM** 

Email: contaminated.land@hbrc.govt.nz



# **Hawkes Bay Regional Council Selected Land Use Register Statement**

Date requested: 10/09/2021 Date generated: 14/09/2021

### PARCEL ENQUIRY REFERENCE:

Property Address(s):	5224 State Highway 2, Putorino, Hastings		
Legal Description(s):	Lot 1 DP 23291, Lot 1 & 2 DP 21459, Pt Section 34 SO 2516, Section 33 SO		
	2516, Lot 1 DP 23044, Lot 1 DP 9366, Section 23 SO 1621, Lot 3 DP 25330,		
	Lot 1 DP 26609, Lot 1 DP 21170, Section 41 SO 6201, Lot 1 DP 25330,		
	Section 22 SO 1621, Part Lot 1 DP 13541, Part Lot 1 DP 13713		
Parcel ID(s):	4173123, 4193875, 4174342, 4217243, 4178234, 4175457, 4180042,		
	4200765, 4191761, 4169617, 4225333, 4177179, 4176113, 4168378,		
	4209983, 4187987		
Valuation	0953009000, 0953009300, 0953009100, 08820000100, 08820000106		
Number(s):			




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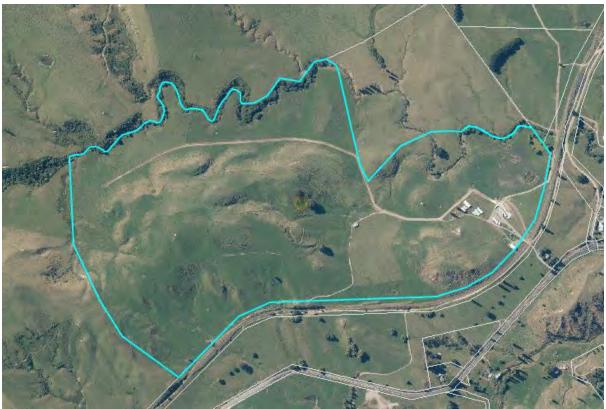
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Lot 2 DP 24159




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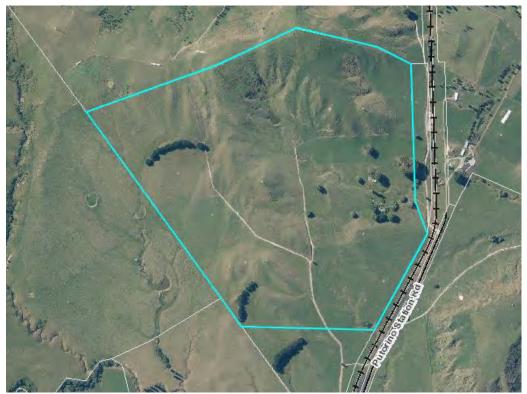
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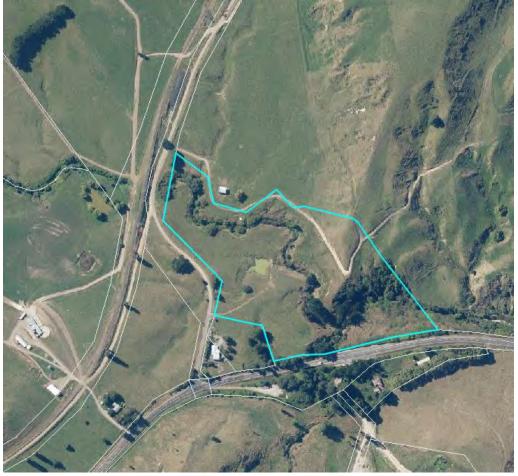
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Lot 1 DP 9366




Section 23 SO 1621

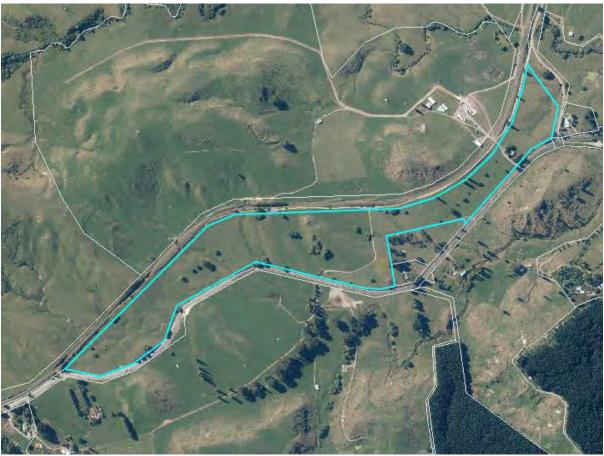

Lot 3 DP 25330

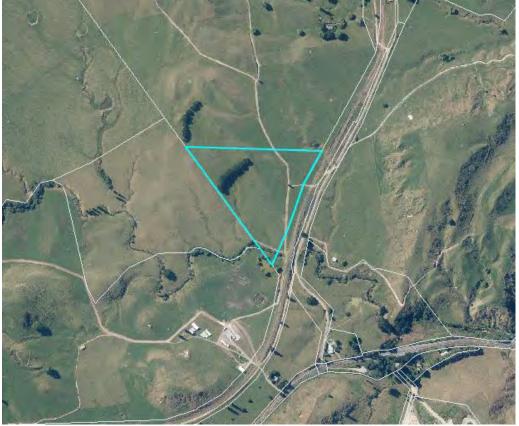

Lot 1 DP 26609

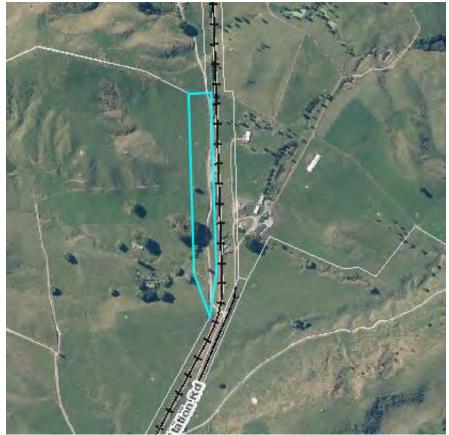


Lot 1 DP 21170




Section 41 SO 6201




Lot 1 DP 25330

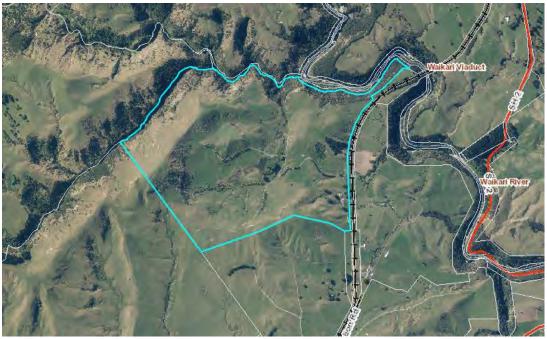

Section 22 SO 1621 Block II Moeangiangi SD

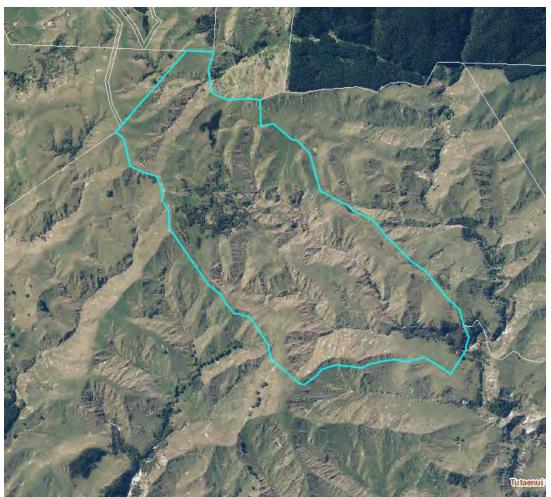

Part Lot 1 DP 13541

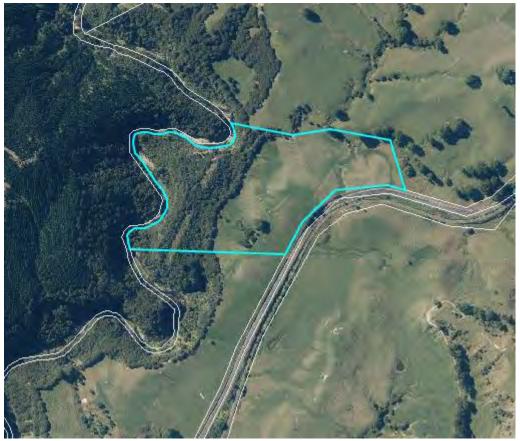

Part Lot 1 DP 13713



The above map outlines the specific parcel(s) or area(s) where contaminated land information has been requested

## SITES WITHIN AREA OF ENQUIRY:

There are no listed sites within the area of enquiry, however all properties are rural and there's the potential for sheep dip and spray traces. Unfortunately, historical imagery show no clear evidence of these types of activities.

#### Resource consents related to the sites:

- Putorino Golf Club (part section 34 SO 2516)
   Water Take Consent (AUTH-108259-01) to take water from well no. 2054 (100 mm diameter) to irrigate golf course greens. Consent expired in 2008.
- 2. Waikare Dairy Co (Section 33 SO 2516)
  Discharge Consent (AUTH-124776-01 & AUTH-124777-01) to discharge farm dairy effluent (including associated sludges and solids) from a herd of up to 650 cows and from the operation of a dairy shed onto land, in circumstances which may result in the contaminant (or any other contaminant emanating as a result of natural processes from that contaminant) entering

water, and to discharge contaminants into air arising from the management of farm dairy effluent.

- 3. Flat Hill Trust (Lot 1 DP 25330)
  - Discharge Consent (AUTH-122768-01) to discharge farm dairy effluent (FDE), generated by a herd of up to 400 cows being milked in a dairy shed, onto land, in circumstances which may result in the contaminant (or any other contaminant emanating as a result of natural processes from that contaminant) entering water, and to discharge contaminants into air arising from the management of that FDE.
  - Bore Permit (AUTH-114593-01) to drill a 100mm bore (No. 5337) for domestic/stock water purposes.
- 4. Mobil Oil NZ Ltd (Part Lot 1 DP 13541) additional property Bore Permit (AUTH-113877-01) to drill bore no. 5129 (50 mm diameter) for monitoring purposes.

#### SITES SURROUNDING AREA OF ENQUIRY:

The are no listed sites within the surrounding area of enquiry

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#### **IDENTIFICATION**

WQ Site:

**Easting:** 1943927.952 **Northing:** 5659722.784

Method:

Address:

## **WELL INFORMATION**

**Drill date:** 14/03/1986

**Driller:** Baylis Brothers Limited

Casing Diameter (mm): 100

Bore Depth (m)

 Well Depth (m):
 85.34

 Screen top (m):
 42.6

 Screen bottom (m):
 60.9

Open hole top (m): Open hole bottom (m):

Water level access: Unknown

## **Aquifer Information**

Inital Water Level -4

Aquifer Condition Confined Aquifer Lithology Other

## **Aquifer Test**

Test Reliability Unreliable

Specific Capacity 0

**Hydralic Conductivity** 

Storativity

**Transmissivity** 

**Aquifer Thickness** 

**Number Of Pumping Steps** 

Duration 4
Maximum Draw Down 17
Maximum Pumping Rate 1

**Report Number** 

Bore No 2054

## Bore Log (m)

**Lithology** TOPSOIL

From Depth 0 To Depth 1

Lithology ASH/PUMICE

From Depth 1 To Depth 1

**Lithology** brown CLAY (light)

From Depth 1

To Depth 2

**Lithology** brown SAND

From Depth 2 To Depth 3

Lithology blue SANDSTONE

From Depth 3
To Depth 7

**Lithology** ASH/PUMICE

From Depth 7
To Depth 7

**Lithology** white CLAY

From Depth 7
To Depth 8

**Lithology** blue CLAY with sand

From Depth 8 To Depth 18

Lithology blue SANDSTONE (soft)

From Depth 18 To Depth 47

**Lithology** blue SAND with shell

From Depth 47 To Depth 48

**Lithology** blue CLAY

From Depth 48 To Depth 51

**Lithology** blue CLAY with sand

From Depth 51 To Depth 58

**Lithology** ASH/PUMICE

From Depth 58 To Depth 59

**Lithology** blue SAND

From Depth 59 To Depth 67

**Lithology** blue CLAY

From Depth 67 To Depth 73 Lithologyblue SANDFrom Depth73To Depth80

**Lithology** blue CLAY

From Depth 80 To Depth 85





#### **IDENTIFICATION**

WQ Site:

Easting: 1944684.875 Northing: 5661218.917 Method: Hand-held GPS

Address: PUTORINO STATION RD

## **WELL INFORMATION**

Drill date: 09/02/2005

**Driller: Baylis Brothers Limited** 

Casing Diameter (mm): 100 Bore Depth (m) 68 68 Well Depth (m): Screen top (m): 44 Screen bottom (m): 68

Open hole top (m): Open hole bottom (m):

Water level access: Yes

#### **Bore Consents**

LU050043B Consent Id **Consent Type** Bore consent

**Use One** Residential - Single property

**Use Two** Potable Supply

## **Aquifer Information**

-16 **Inital Water Level Aquifer Condition** Confined **Aquifer Lithology** Other

## Bore Log (m)

**TOPSOIL** Lithology

From Depth 0 0 To Depth

Lithology brown CLAY with ash/pumice

From Depth 0 To Depth 6

Lithology brown SANDSTONE (with blue layers)

From Depth 6 24 To Depth

SAND with ash/pumice Lithology

From Depth 24 To Depth 24

Lithology blue CLAY 24

From Depth

To Depth 36

**Lithology** white CLAY with ash/pumice

From Depth 36 To Depth 36

**Lithology** blue CLAY

From Depth 36 To Depth 38

**Lithology** blue SANDSTONE (water bearing)

From Depth 38 To Depth 55

**Lithology** blue CLAY

From Depth 55 To Depth 55

**Lithology** blue SANDSTONE (water bearing)

From Depth 55 To Depth 63

**Lithology** blue SAND (soft (water bearing))

From Depth 63 To Depth 68



TE KAUNIHERA Ā-ROHE O TE MATAU-A-MĀUI

# RESOURCE CONSENT

# **Discharge Permit**

In accordance with the provisions of the Resource Management Act 1991 (RMA), and subject to the attached conditions, the Hawke's Bay Regional Council (the Council) grants a resource consent for a controlled activity to:

**Waikare Dairy Company Limited** 

5100 State Highway 2 RD 1 Kotemaori Hawke's Bay 4188

to discharge farm dairy effluent (including associated sludges and solids) from a herd of up to 650 cows and from the operation of a dairy shed onto land, in circumstances which may result in the contaminant (or any other contaminant emanating as a result of natural processes from that contaminant) entering water and to discharge contaminants into air arising from the management of that FDE.

## **LOCATION**

**Address of site:** 5257 State Highway 2, Putorino, Hawke's Bay,

Legal description (site of discharge): Sec 33 SO 2516, Sec 34 SO 2516, Lot 1 DP 23044, Lot 1

DP 9366 and Sec 23 SO 1621

Map reference:

	NZTM				
Feature	Easting	Northing			
Dairy Shed	1944171	5660170			
Storage Pond:	1944251	5660273			

#### **CONSENT DURATION**

This consent is granted for a period expiring on 31 May 2030.

Paul Barrett
Team Leader Consents
POLICY AND REGULATION GROUP

Under authority delegated by Hawke's Bay Regional Council
26 February 2021

#### **Conditions**

- All works and structures relating to this resource consent shall be designed and constructed to conform to the best engineering practices and at all times maintained to a safe and serviceable standard.
- 2. The effluent discharged shall be from the milking of no more than **325 cows once per day and 325 cows twice per day**.
- 3. All effluent from the dairy shed shall be collected in an effluent storage pond(s) with a minimum working capacity of **1,698** m³ (See Advice Note 1).
- 4. The consent holder shall ensure that a minimum of **500 mm freeboard** is maintained in the holding pond(s) over periods when there is no rainfall. The freeboard shall be maintained over and above the minimum holding capacity specified in Condition 3 of this consent.
- 5. The consent holder shall ensure that:
  - a) Any accumulated sludge in the effluent storage pond is removed annually to maintain the capacity of the holding pond as stated in Condition 3.
  - b) That effluent is applied to land whenever soil conditions are suitable.
- 6. All effluent storage facilities shall be designed, constructed and maintained to ensure that there is no measurable leakage of effluent from the storage facility.
- 7. The consent holder shall ensure that clean stormwater from the dairy shed yard shall be diverted so that it does not enter the effluent storage pond during periods when the yard is clean and is not in daily use.
- 8. The consent holder shall engage a suitably qualified and experienced person to undertake a test on each pond to estimate the permeability and leakage of each pond using a Pond Drop Test. The Pond Drop Test shall be undertaken using a method that is consistent with that set out in IPENZ "Practice Note 21 Farm Dairy Effluent" (Version 3, August 2017). A written report from a suitably qualified person shall be provided to the Council (Manager Compliance) prior to 31 May 2022. This report will be used to confirm compliance with Condition 6.
- 9. The consent holder shall provide the Council (Manager Compliance) in writing, notice of any intended installation of any new or replacement effluent storage facilities. The consent holder shall include with this notice, details of the proposed facilities, including storage volumes, location, and construction methods. This shall be provided at least 20 working days prior to commencement of installation of any storage facilities.
- 10. Any new or replacement effluent storage facilities shall:
  - a) Ensure that a total minimum working effluent storage capacity of **1,682 m³** is provided.
  - b) Be lined with an impermeable liner. Documentation from the manufacturer and installer (including 'As built' plans, a signed Producer Statement and membrane manufacturer quality assurance statements) shall be provided confirming that the liner ensures a permeability not exceeding 1 x 10<sup>-9</sup> m/s. This shall be provided to the Council (Manager Compliance) within three months of completion of the new effluent storage facility. (See Advice Note 6).
- 11. The effluent irrigated to land shall be spread over a minimum area of 22 hectares annually.
- 12. The effluent land application area shall be located within the area identified in **Appendix 1** attached to and forming part of this consent.

- 13. The rate of effluent application to land shall not exceed the soil infiltration rate and shall not exceed a maximum application depth of **18 mm** at any one time.
- 14. Effluent shall not be applied to the same piece of land more than once in any 20 day period.
- 15. The total nitrogen loading rate resulting from the application of farm dairy effluent to land shall not exceed **150 kg/ha/year**.
- 16. The consent holder shall calibrate the effluent irrigator at least twice per year (see Advice Notes 2 and 3).
- 17. No effluent shall be discharged, either directly or indirectly through spray drift, within:
  - a) **20 metres** of any continuously flowing or ephemeral water body;
  - b) **90 metres** from any water supply used for human consumption;
  - c) **10 metres** of any property boundary, unless written approval has been obtained from the owner or occupier;
  - d) 20 metres of any public road,
  - e) **90 metres** of any off-site residential dwelling, unless written approval has been obtained from the owner or occupier.
- 18. There shall be no run-off, or ponding of effluent on the soil surface.
- 19. The consent holder shall record and provide to Council (Manager Compliance) the following information by **31 May** each year, and at the time of a monitoring inspection:
  - a) Details of the calculation of the travelling irrigator and slurry wagon application rate (in mm per pass).
  - b) A map showing the location of the paddocks over which the discharge takes place (including paddock identification) and the area of each paddock that can be irrigated (in hectares)
  - c) A daily record of each paddock over which the discharge took place (including paddock and run identification), the number of passes and the method of application (i.e. slurry wagon or travelling irrigator).
  - d) The number of cows milked at the beginning of each month.
  - e) A photo of the pond when the pond level is low to demonstrate compliance with Condition 5 (a lack of accumulated sludge).
- 20. The consent holder shall ensure a sample of the farm dairy effluent is taken from under the irrigator during the months of September, December and February and this shall be analysed for Total Nitrogen. All effluent sampling shall be carried out by a suitably qualified person as authorised by the Council (Manager Compliance). These results may be used in the Overseer Nutrient Budget.
- 21. All effluent analyses shall be carried out by an independently accredited laboratory in accordance with the Standard Methods for the Examination of Water and Wastewater published jointly by the American Public Health Association, American Wastewater Association, and Water Environment Federation, or any other equivalent method with the approval of the Council (Manager Compliance).

- 22. The results of analyses undertaken in accordance with the conditions of this consent shall be forwarded to Council (Manager Compliance) within one month of sampling.
- 23. That where, for any cause (accidental or otherwise), wastes associated with the consent holder's operations escape to water, the consent holder shall:
  - a) Immediately take all practicable steps to contain and then remove the contamination from the environment, and;
  - b) Immediately notify the Council of the escape, and;
  - c) Report to the Council, in writing and within 7 days, describing the manner and cause of the escape and steps taken to control it and prevent its recurrence.
- 24. The nutrient budget supplied with this application shall be updated and supplied to the Council (Manager Compliance) by 1 October each year for the previous milking season (1 June to 30 May) (i.e. the most recently past season, using actual inputs rather than forecast inputs). All input data must be provided with the OverseerFM nutrient budget, which shall be published to the Council using OverseerFM.
- 25. There shall be no offensive or objectionable odour, or noxious or dangerous levels of gases or other airborne liquid contaminants, discharged beyond the boundary of the subject property.
- 26. The consent holder shall log all complaints received. The log shall include:
  - a) the date & time,
  - b) nature of the complaint,
  - c) the name, telephone number, and address of the complainant,
  - d) weather information (an estimate of wind speed and direction),
  - e) details of key operating parameters at the time of the complaint, and
  - f) the remedial action taken to prevent further incidents.

Complaints shall be reported to the Council within 24 hours of receipt and the log of complaints shall be made available to the Council on request.

- 27. The conditions of this consent may be reviewed by Council during the month of May of any year pursuant to sections 128, 129, 130, 131 and 132 of the RMA. The actual and reasonable costs of any review undertaken will be charged to the consent holder, in accordance with section 36 of the RMA. The consent(s) may be reviewed for any of the following purposes:
  - a) To deal with any adverse effect on the environment which may arise from the exercise of these consents, which it is appropriate to deal with at that time, or which became evident after the date of issue.
  - b) To require the adoption of the best practicable option to remove or reduce any adverse effects on the environment.
  - c) To modify any monitoring programme, or to require additional monitoring if there is evidence that current monitoring requirements are inappropriate or inadequate.
  - d) To modify or add any condition to ensure that the discharge is in accordance with an operative plan.
  - e) To require a de-activation device to be installed on the irrigation system.

#### **REASONS FOR DECISION**

The effects of the activity on the environment will not be more than minor. Granting the consent is consistent with the purpose and principles of the RMA, the requirements of any relevant NPS, Regulations, NES regulations and with all relevant plans and policies.

#### **ADVICE NOTES**

- 1. Condition 3 specifies the estimated working capacity of the existing ponds. 'Working capacity' means the actual storage volume once allowance for freeboard (0.5 m at the top of a pond) and unpumpable sludge (0.5 m at base of pond) is made.
- 2. To calibrate a travelling irrigator or muck spreader, place approximately 4 flat bottom and straight wall containers in a random pattern in front of the irrigator. After the irrigator has passed over the containers measure the depth of effluent in each container and average the depth.
- 3. To determine the application rate of a stationary irrigator/sprinkler, place approximately 4 flat bottom and straight wall containers in a random pattern around the irrigator/sprinkler at various distances to capture effluent. Time the discharge for a minimum of 5 minutes and shut the discharge off. Measure the depth of effluent in each container and average the depth. Divide the average depth by the period of time.
- 4. Effluent includes, for the purposes of this consent, farm dairy effluent including any effluent spray irrigated from the pond or storage tank plus any sludge or crusted material when excavated from ponds. These materials are subject to these conditions.
- 5. All information required by the conditions of this consent can be provided to the council by email to ComplianceReturns@hbrc.govt.nz .
- 6. If a new pond is installed, the consent holder should also ensure that an under-pond leak detection system is also installed during construction of the pond. This will provide a suitable means of testing the pond for leakage in the future.

## MONITORING BY THE COUNCIL

#### **Routine monitoring**

Routine monitoring inspections will be undertaken by Council officers at a frequency of no more than twice every year to check compliance with the conditions of the consent. The costs of **any** routine monitoring will be charged to the consent holder in accordance with Council's Annual Plan of the time.

## Non-routine monitoring

"Non routine" monitoring will be undertaken if there is cause to consider (e.g. following a complaint from the public, or routine monitoring) that the consent holder is in breach of the conditions of this consent. The cost of non-routine monitoring will be charged to the consent holder in the event that non-compliance with conditions is determined, or if the consent holder is deemed not to be fulfilling the obligations specified in section 17(1) of the RMA.

Section 17(1) of the RMA states:

Every person has a duty to avoid, remedy, or mitigate any adverse effect on the environment arising from an activity carried on by or on behalf of the person, whether or not the activity is carried on in accordance with

- a) any of sections 10, 10A, 10B, and 20A; or
- b) a national environmental standard, a rule, a resource consent, or a designation.

## **Consent Impact Monitoring**

In accordance with section 36 of the RMA (which includes the requirement to consult with the consent holder) the Council may levy additional charges for the cost of monitoring the environmental effects of this consent, either in isolation or in combination with other nearby consents. Any such charge would generally be set through the Annual Plan process.

#### **DEBT RECOVERY**


It is agreed by the consent holder that it is a term of the granting of this resource consent that all costs incurred by the Council for, and incidental to, the collection of any debt relating to this resource consent, whether as an individual or as a member of a group, and charged under section 36 of the RMA, shall be borne by the consent holder as a debt due to the Council, and for that purpose the Council reserves the right to produce this document in support of any claim for recovery.

## **CONSENT HISTORY**

Authorisation No.	Date	Event	Relevant Rule	Relevant Plan
AUTH-124776-01, AUTH-124777-01	26/02/2021	Consent initially granted	14	Regional Resource Management Plan

## APPENDIX 1: EFFLUENT LAND APPLICATION AREAS AND BUFFER ZONES



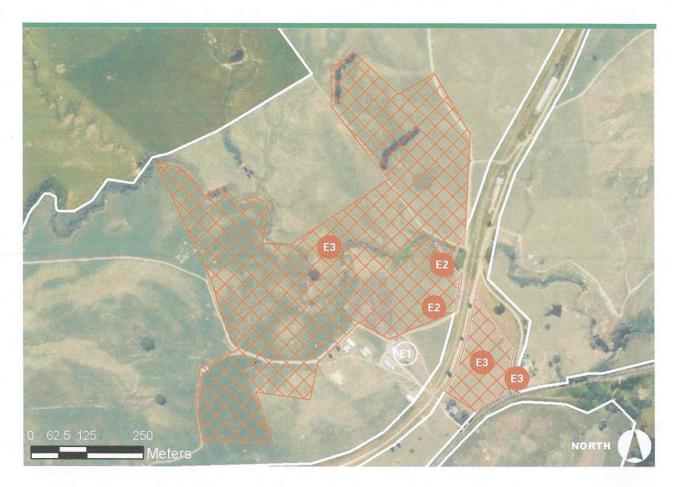

- Effluent System Stone trap and Stormwater Diversion
- E2 Effluent Storage Effluent Ponds





# RESOURCE CONSENT

**Discharge Permit** 

In accordance with the provisions of the Resource Management Act 1991 (RMA), and subject to the attached conditions, the Hawke's Bay Regional Council (the Council) grants a resource consent for a controlled activity to:

Gary Stephen MACKINTOSH, Brian Neil LESSELS and Stephen Peter LUNN Trustees of Flat Hill Trust

151 Putorino Station Road RD 1 Kotemaori 4188

to discharge farm dairy effluent (FDE), generated by a herd of up to 400 cows being milked in a dairy shed, onto land, in circumstances which may result in the contaminant (or any other contaminant emanating as a result of natural processes from that contaminant) entering water, and to discharge contaminants into air arising from the management of that FDE.

#### LOCATION

Address of site: 100 Putorino Station Road, Kotemaori

**Legal description** (site of discharge): Lot 1 DP 25330

Map reference:

	NZ	ZTM	NZMG		
Feature	Easting	Northing	Easting	Northing	
Dairy Shed:	1944707	5661183	2854679	6222758	
Storage Pond:	1944753	5661304	2854725	6222878	
Effluent Land Application Area:	1944854	5661169	2854825	6222744	

## **CONSENT DURATION**

This consent is granted for a period commencing on 1 June 2018 and expiring on 31 May 2028.

Paul Barrett Principal Consents Planner EXTERNAL RELATIONS GROUP

Under authority delegated by Hawke's Bay Regional Council  $29^{th}\ May\ 2018$ 

#### **CONDITIONS**

- All works and structures relating to this resource consent shall be designed and constructed to conform to the best engineering practices and at all times maintained to a safe and serviceable standard.
- 2. The effluent discharged shall be from the milking of no more than 400 cows twice per day.
- 3. All effluent from the dairy shed shall be collected in the existing effluent storage pond/s that have a minimum working capacity of **874 m³** (See Advice Note 1).
- 4. The consent holder shall ensure that a minimum of **500 mm freeboard** is maintained in the effluent storage pond/s required by Condition 3 over periods when there is no rainfall. The freeboard shall be maintained over and above the minimum holding capacity specified in Condition 3.
- 5. The consent holder shall ensure that any accumulated sludge in the effluent storage pond/s is removed each year, to maintain the working capacity of the effluent storage pond/s as stated in Condition 3.
- 6. All effluent storage facilities shall be designed, constructed and maintained to ensure that there is no measurable leakage of effluent from the storage facility.
- 7. The consent holder shall engage a suitably qualified and experienced person to undertake a test of the pond's permeability and leakage using a Pond Drop Test. The Pond Drop Test shall be undertaken using a method that is consistent with that set out in IPENZ "Practice Note 21 Farm Dairy Effluent" (version 3, August 2017). A written report from a suitably qualified person shall be provided to the Council (Manager Compliance) prior to 31 May 2019. This report will be used to confirm compliance with Condition 6.
- 8. The effluent irrigated to land shall be spread over a minimum area of **11** hectares annually.
- 9. The effluent land application area shall be located within the area identified in **Appendix 1** attached to and forming part of this consent.
- 10. The rate of effluent application to land shall not exceed the soil infiltration rate and shall not exceed a maximum application rate of 5 mm/hr. The maximum application depth at any one time shall not exceed 15 mm.
- 11. Effluent shall not be applied to the same piece of land more than once in any **7 day period**.
- 12. The total nitrogen loading rate resulting from the application of farm dairy effluent to land shall not exceed **150 kg/ha/year**.
- 13. The consent holder shall calibrate the effluent irrigator at least twice per year (see Advice Notes 2 and 3).
- 14. No effluent shall be discharged, either directly or indirectly through spray drift, within:
  - a) 20 metres of any continuously flowing or ephemeral water body;
  - b) **90 metres** from any water supply used for human consumption, and **30 m** from any other well;
  - c) **10 metres** of any property boundary, unless written approval has been obtained from the owner or occupier;
  - d) 20 metres of any public road,
  - e) **90 metres** of any off-site residential dwelling, unless written approval has been obtained from the owner or occupier.

- 15. There shall be no run-off, or ponding of effluent on the soil surface.
- 16. The consent holder shall record and provide to Council (Manager Compliance) on request and at the time of a monitoring inspection the following information;
  - a) Details of the calculation of the irrigator application rate (in mm per pass).
  - b) A map showing the location of the paddocks over which the discharge takes place (including paddock identification) and the area of each paddock that can be irrigated (in hectares).
  - c) A daily record of each paddock over which the discharge took place (including paddock identification) and the number of passes.
  - d) The number of cows milked at the beginning of each month.
- 17. The consent holder shall ensure a sample of the farm dairy effluent is taken from under the irrigator annually and analysed for Total Nitrogen. All effluent sampling shall be carried out by a suitably qualified person as authorised by the Council (Manager Compliance). These results may be used in the Overseer Nutrient Budget.
- 18. All effluent analyses shall be carried out by an independently accredited laboratory in accordance with the Standard Methods for the Examination of Water and Wastewater published jointly by the American Public Health Association, American Wastewater Association, and Water Environment Federation, or any other equivalent method with the approval of the Council (Manager Compliance)
- 19. The results of analyses undertaken in accordance with the conditions of this consent shall be forwarded to Council (Manager Compliance) within one month of sampling.
- 20. The consent holder shall check the effluent irrigation system regularly when it is in use to ensure it is operating correctly.
- 21. That where, for any cause (accidental or otherwise), wastes associated with the consent holder's operations escape to water, the consent holder shall:
  - a) Immediately take all practicable steps to contain and then remove the contamination from the environment, and;
  - b) Immediately notify the Council of the escape, and;
  - c) Report to the Council, in writing and within 7 days, describing the manner and cause of the escape and steps taken to control it and prevent its recurrence
- 22. The nutrient budget supplied with this application shall be updated and supplied to the Council (Manager Compliance) by 1 October each year for the previous milking season (1 June to 30 May) (i.e. the most recently past season, using actual inputs rather than forecast inputs). All input data must be provided with the budget, which shall be supplied in both hard copy and an electronic ovp file.
- 23. There shall be no offensive or objectionable odour, or noxious or dangerous levels of gases or other airborne liquid contaminants, discharged beyond the boundary of the subject property.
- 24. The effluent storage pond shall not be located within 300 metres of any off-site residential dwelling, unless written approval has been obtained from the owner or occupier.
- 25. If an event occurs on-site that may lead to groundwater contamination, the consent holder shall notify the Putorino School and the Hawke's Bay Regional Council (Manager Compliance) of the event as soon as reasonably practicable after the event occurs.

<u>Advice Note:</u> Such an event might include for example an overflow of the effluent storage pond. The Putorino School can be contacted on (06) 839 7336. The Regional Council 24 hour Pollution Hotline should also be contacted on 0800 108 838.

- 26. The consent holder shall log all complaints received. The log shall include:
  - a) The date & time,
  - b) Nature of the complaint,
  - c) The name, telephone number, and address of the complainant,
  - d) Weather information (an estimate of wind speed and direction),
  - e) Details of key operating parameters at the time of the complaint, and
  - f) The remedial action taken to prevent further incidents.

Complaints shall be reported to the Council within 24 hours of receipt and the log of complaints shall be made available to the Council on request.

#### REVIEW OF CONSENT CONDITIONS BY THE COUNCIL

The Council may review conditions of these consents pursuant to sections 128, 129, 130, 131 and 132 of the RMA. The actual and reasonable costs of any review undertaken will be charged to the consent holder, in accordance with section 36 of the RMA.

Times of service of notice of any review: During the month of May, of any year.

Purposes of review:

To deal with any adverse effect on the environment which may arise from the exercise of these consents, which it is appropriate to deal with at that time, or which became evident after the date of issue.

To require the adoption of the best practicable option to remove or reduce any adverse effects on the environment.

To modify any monitoring programme, or to require additional monitoring if there is evidence that current monitoring requirements are inappropriate or inadequate.

To modify or add any condition to ensure that the discharge is in accordance with an operative plan.

To require the installation of a de-activation device and/or alarm on the irrigator.

#### **REASONS FOR DECISION**

The effects of the activity on the environment will not be more than minor. Granting the consent is consistent with the purpose and principles of the RMA, the requirements of any relevant NPS, Regulations, NES regulations and with all relevant plans and policies.

## **ADVICE NOTES**

- 1. 'Working capacity' means the actual storage volume once allowance for freeboard (0.5 m at the top of a pond) and unpumpable sludge (0.5 m at base of pond) is made.
- To calibrate a travelling irrigator or muck spreader, place approximately 4 flat bottom and straight wall containers in a random pattern in front of the irrigator. After the irrigator has passed over the containers measure the depth of effluent in each container and average the depth.
- 3. To determine the application rate of a stationary irrigator/sprinkler, place approximately 4 flat bottom and straight wall containers in a random pattern around the irrigator/sprinkler at various distances to capture effluent. Time the discharge for a minimum of 5 minutes and shut the

- discharge off. Measure the depth of effluent in each container and average the depth. Divide the average depth by the period of time.
- 4. Effluent includes, for the purposes of this consent, farm dairy effluent including any effluent spray irrigated from the pond or storage tank plus any sludge or crusted material when excavated from ponds. These materials are subject to these conditions.
- 5. All information required by the conditions of this consent can be provided to the council by email to ComplianceReturns@hbrc.govt.nz.

#### MONITORING BY THE COUNCIL

## **Routine monitoring**

Routine monitoring inspections will be undertaken by Council officers at a frequency of no more than once every year to check compliance with the conditions of the consent. The costs of **any** routine monitoring will be charged to the consent holder in accordance with Council's Annual Plan of the time.

## Non-routine monitoring

"Non routine" monitoring will be undertaken if there is cause to consider (e.g. following a complaint from the public, or routine monitoring) that the consent holder is in breach of the conditions of this consent. The cost of non-routine monitoring will be charged to the consent holder in the event that non-compliance with conditions is determined, or if the consent holder is deemed not to be fulfilling the obligations specified in section 17(1) of the RMA.

Section 17(1) of the RMA states:

Every person has a duty to avoid, remedy, or mitigate any adverse effect on the environment arising from an activity carried on by or on behalf of the person, whether or not the activity is carried on in accordance with

- a) any of sections 10, 10A, 10B, and 20A; or
- b) a national environmental standard, a rule, a resource consent, or a designation.

## **Consent Impact Monitoring**

In accordance with section 36 of the RMA (which includes the requirement to consult with the consent holder) the Council may levy additional charges for the cost of monitoring the environmental effects of this consent, either in isolation or in combination with other nearby consents. Any such charge would generally be set through the Annual Plan process.


#### **DEBT RECOVERY**

It is agreed by the consent holder that it is a term of the granting of this resource consent that all costs incurred by the Council for, and incidental to, the collection of any debt relating to this resource consent, whether as an individual or as a member of a group, and charged under section 36 of the RMA, shall be borne by the consent holder as a debt due to the Council, and for that purpose the Council reserves the right to produce this document in support of any claim for recovery.

## **CONSENT HISTORY**

Consent No.	Date	Event	Relevant Rule		Relevant Rule	
(Version)			Number	Plan		
DP170556L	29/05/2018	Consent initially granted	14	Regional Resource Management Plan		

# APPENDIX ONE: EFFLUENT LAND APPLICATION AREA (BOUNDARIES OUTLINED IN BLACK)

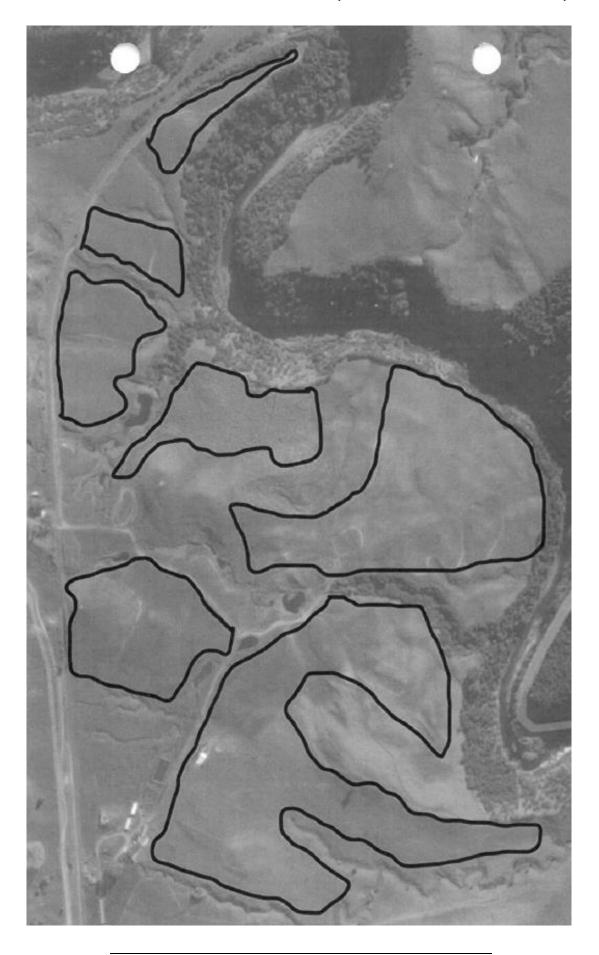

#### **Max van Stom**

From: Hinetaakoha Viriaere <Hinetaakoha@wairoadc.govt.nz>

Sent: Friday, 10 September 2021 16:04

To: Max van Stom

**Subject:** RE: Property File Information - Contamination

**Attachments:** Copy of Property List - WDC.xlsx; Copy of 20170628\_WDCHotspot.xlsx

You don't often get email from hinetaakoha@wairoadc.govt.nz. Learn why this is important

Kia ora Max

Please see attached list as discussed. There are no resource consents associated with the sites shown in attached property list.

Let me know if you require any further information thanks.

Ngā mihi Hine Viriaere

Kaiwhakamahere Matua | Senior Planner



# WAIROA DISTRICT COUNCIL

Coronation Square, 97-103 Queen Street, Wairoa 4108 | PO Box 54, Wairoa 4160

www.wairoadc.govt.nz | Facebook

Hapori Tühono | Āhua Noho Tōrere | Taiao Piki Kōtuku | Ōhanga Taurikura / Connecte Communities | Desirable Lifestyles | Treasured Environments | Thriving Economy

<b>Authority</b>	Address	Legal description	Certificate of title	Area (ha)
VVI )( ;	5517 State Highway 2, Putorino 5556 State Highway 2, Putorino	Part Lot 1 DP 13541	HBG3/1433	227.82
WDC	5500 State Highway 2, Putorino	Part Lot 1 DP 13713	HBF4/1448	98.42

ID SiteType	NZSIC_Description	ClassificationCategory	ClassificationSubCategory		ssRapid AddressNo	AddressRoadName
1397 Service Stations	Transport Operators	Land-use	Unverified HAIL	Commercial/Industrial	12	Frasertown Road, SH 38
1398 Power Generation and Distribution	Power Stations	Land-use	Remediated for <land use=""></land>	Commercial/Industrial		Kaitawa Hydro Power Stn, SH 38
1398 Power Generation and Distribution	Power Stations	Land-use	Remediated for <land use=""></land>	Commercial/Industrial		Kaitawa Hydro Power Stn, SH 38
1398 Power Generation and Distribution	Power Stations	Land-use	Remediated for <land use=""></land>	Commercial/Industrial		Kaitawa Hydro Power Stn, SH 38
1398 Power Generation and Distribution	Power Stations	Land-use	Remediated for <land use=""></land>	Commercial/Industrial		Kaitawa Hydro Power Stn, SH 38
1398 Power Generation and Distribution	Power Stations	Land-use	Remediated for <land use=""></land>	Commercial/Industrial		Kaitawa Hydro Power Stn, SH 38
1398 Power Generation and Distribution	Power Stations	Land-use	Remediated for <land use=""></land>	Commercial/Industrial		Kaitawa Hydro Power Stn, SH 38
1398 Power Generation and Distribution	Power Stations	Land-use	Remediated for <land use=""></land>	Commercial/Industrial		Kaitawa Hydro Power Stn, SH 38
1398 Power Generation and Distribution	Power Stations	Land-use	Remediated for <land use=""></land>	Commercial/Industrial		Kaitawa Hydro Power Stn, SH 38
1399 Landfill Sites	Landfills	Land-use	Not investigated	Commercial/Industrial		Kaitawa Tip
1401 Landfill Sites	Landfills	Land-use	Partially investigated	Commercial/Industrial		Mahia Beach Tip
1402 Service Stations	Garages	Land-use	Not investigated	Commercial/Industrial	13	Bridge St
1402 Service Stations	Garages	Land-use	Not investigated	Commercial/Industrial	13	Bridge St
1402 Service Stations	Garages	Land-use	Not investigated	Commercial/Industrial	13	Bridge St
1402 Service Stations	Garages	Land-use	Not investigated	Commercial/Industrial	13	Bridge St
1408 Wood Treatment and Preservation	Timber Merchants & Sawmills	Land-use	Not investigated	Commercial/Industrial		Carroll St
1408 Wood Treatment and Preservation	Timber Merchants & Sawmills	Land-use	Not investigated	Commercial/Industrial		Carroll St
1408 Wood Treatment and Preservation	Timber Merchants & Sawmills	Land-use	Not investigated	Commercial/Industrial		Carroll St
1408 Wood Treatment and Preservation	Timber Merchants & Sawmills	Land-use	Not investigated	Commercial/Industrial		Carroll St
408 Wood Treatment and Preservation	Timber Merchants & Sawmills	Land-use	Not investigated	Commercial/Industrial		Carroll St
1408 Wood Treatment and Preservation	Timber Merchants & Sawmills	Land-use	Not investigated	Commercial/Industrial		Carroll St
1408 Wood Treatment and Preservation	Timber Merchants & Sawmills	Land-use	Not investigated	Commercial/Industrial		Carroll St
1428 Service Stations	Transport Operators	Land-use	Not investigated	Commercial/Industrial	145	Carroll Street
1428 Service Stations	Transport Operators	Land-use	Not investigated	Commercial/Industrial	145	Carroll Street
1429 Oil Production and Storage	Petrol & Oil Companies	Land-use	Unverified HAIL	Commercial/Industrial	55	Carroll St
1429 Oil Production and Storage	Petrol & Oil Companies	Land-use	Unverified HAIL	Commercial/Industrial	55	Carroll St
1433 Wood Treatment and Preservation	Timber Merchants & Sawmills	Land-use	Partially investigated	Commercial/Industrial	2	McDonald Street
1433 Wood Treatment and Preservation	Timber Merchants & Sawmills	Land-use	Partially investigated	Commercial/Industrial	2	McDonald Street
			· · · · · · · · · · · · · · · · · · ·		2	McDonald Street
1433 Wood Treatment and Preservation	Timber Merchants & Sawmills	Land-use	Partially investigated	Commercial/Industrial	2	
1433 Wood Treatment and Preservation	Timber Merchants & Sawmills	Land-use	Partially investigated	Commercial/Industrial	2	McDonald Street
1433 Wood Treatment and Preservation	Timber Merchants & Sawmills	Land-use	Partially investigated	Commercial/Industrial		McDonald Street
1433 Wood Treatment and Preservation	Timber Merchants & Sawmills	Land-use	Partially investigated	Commercial/Industrial	2	McDonald Street
1433 Wood Treatment and Preservation	Timber Merchants & Sawmills	Land-use	Partially investigated	Commercial/Industrial	2	McDonald Street
1433 Wood Treatment and Preservation	Timber Merchants & Sawmills	Land-use	Partially investigated	Commercial/Industrial	2	McDonald Street
1433 Wood Treatment and Preservation	Timber Merchants & Sawmills	Land-use	Partially investigated	Commercial/Industrial	2	McDonald Street
1433 Wood Treatment and Preservation	Timber Merchants & Sawmills	Land-use	Partially investigated	Commercial/Industrial	2	McDonald Street
1434 Landfill Sites	Landfills	Land-use	Partially investigated	Commercial/Industrial	127	Blucks Pitt Rd
1434 Landfill Sites	Landfills	Land-use	Partially investigated	Commercial/Industrial	127	Blucks Pitt Rd
1436 Service Stations	Garages	Land-use	Hazardous substances acceptable for <land use=""></land>	Commercial/Industrial		Main Road. RD 8
1436 Service Stations	Garages	Land-use	Hazardous substances acceptable for <land use=""></land>	Commercial/Industrial		Main Road. RD 8
1438 Service Stations	Service Stations	Land-use	Hazardous substances acceptable for <land use=""></land>	Commercial/Industrial		State Highway 2
1439 Service Stations	Service Stations	Land-use	Not investigated	Commercial/Industrial	1484	Nuhaka Opoutama Road
1439 Service Stations	Service Stations	Land-use	Not investigated	Commercial/Industrial	1484	Nuhaka Opoutama Road
1440 Power Generation and Distribution	Power Stations	Land-use	Not investigated	Commercial/Industrial	4488	Piripaua Hydro Power Stn, SH 38
1440 Power Generation and Distribution	Power Stations	Land-use	Not investigated	Commercial/Industrial	4488	Piripaua Hydro Power Stn, SH 38
1440 Power Generation and Distribution	Power Stations	Land-use	Not investigated	Commercial/Industrial	4488	Piripaua Hydro Power Stn, SH 38
1441 Service Stations	Service Stations	Land-use	Not investigated	Commercial/Industrial	1100	State Highway 2
1443 Power Generation and Distribution	Power Stations	Land-use	Not investigated	Commercial/Industrial		Tuai Hydro Power Stn
1443 Power Generation and Distribution	Power Stations	Land-use	Not investigated  Not investigated	Commercial/Industrial		Tuai Hydro Power Stn
1443 Power Generation and Distribution	Power Stations	Land-use	Not investigated  Not investigated	Commercial/Industrial		Tuai Hydro Power Stn
1443 Power Generation and Distribution				Commercial/Industrial		
	Power Stations	Land-use	Not investigated			Tuai Hydro Power Stn
1443 Power Generation and Distribution	Power Stations	Land-use	Not investigated	Commercial/Industrial		Tuai Hydro Power Stn
1443 Power Generation and Distribution	Power Stations	Land-use	Not investigated	Commercial/Industrial		Tuai Hydro Power Stn
1443 Power Generation and Distribution	Power Stations	Land-use	Not investigated	Commercial/Industrial		Tuai Hydro Power Stn
1443 Power Generation and Distribution	Power Stations	Land-use	Not investigated	Commercial/Industrial		Tuai Hydro Power Stn
1443 Power Generation and Distribution	Power Stations	Land-use	Not investigated	Commercial/Industrial		Tuai Hydro Power Stn
1443 Power Generation and Distribution	Power Stations	Land-use	Not investigated	Commercial/Industrial		Tuai Hydro Power Stn
1445 TOWER GENERALION and Distribution						

Chart and	NIZCIO Deservisione			A Live		Address
elD SiteType	NZSIC_Description	ClassificationCategory	ClassificationSubCategory	LandUse AddressRa	apid AddressNo	AddressRoadName
1443 Power Generation and Distribution	Power Stations	Land-use	Not investigated	Commercial/Industrial		Tuai Hydro Power Stn
1443 Power Generation and Distribution	Power Stations	Land-use	Not investigated	Commercial/Industrial		Tuai Hydro Power Stn
1444 Landfill Sites	Landfills	Land-use	Not investigated	Commercial/Industrial		Tuai Tip
1446 Ports	Ports	Land-use	Not investigated	Commercial/Industrial		Waikokopu
1446 Ports	Ports	Land-use	Not investigated	Commercial/Industrial		Waikokopu
1452 Agricultural/Horticultural Activities	Meat Slaughtering	Land-use	Not investigated  Not investigated	Commercial/Industrial	203	Awamate Rd
• •	<u> </u>	Land-use		Commercial/Industrial	111	Clyde Rd
1458 Service Stations	Garages Most Slaughtoring		Not investigated	<u>`</u>		
1466 Agricultural/Horticultural Activities	Meat Slaughtering	Land-use	Not investigated	Commercial/Industrial	80	Hunterbrown St
1466 Agricultural/Horticultural Activities	Meat Slaughtering	Land-use	Not investigated	Commercial/Industrial	80	Hunterbrown St
1471 Agricultural/Horticultural Activities	Fertilizers	Land-use	Not investigated	Commercial/Industrial		Kaimoana Rd
1472 Railway Yards	Rail Siding	Land-use	Not investigated	Commercial/Industrial		Kaumoana Rd
1474 Miscellaneous	Tyre Retail Workshop	Land-use	Not investigated	Commercial/Industrial	3	Archilles Street
1474 Miscellaneous	Tyre Retail Workshop	Land-use	Not investigated	Commercial/Industrial	3	Archilles Street
1474 Miscellaneous	Tyre Retail Workshop	Land-use	Not investigated	Commercial/Industrial	3	Archilles Street
1476 Service Stations	Panel-Beaters & Motor Body Builders	Land-use	Not investigated	Commercial/Industrial	Cnr	Lucknow St and Achilles Street/SH2
1487 Service Stations	Transport Operators	Land-use	Not investigated	Commercial/Industrial	CIII	Marine Parade
1488 Agricultural/Horticultural Activities	Chemicals-Agricultural	Land-use	Not investigated	Commercial/Industrial	40 & 42	Marine Parade
		Land-use	-	Commercial/Industrial	40 & 42	
1488 Agricultural/Horticultural Activities	Chemicals-Agricultural		Not investigated	<u>`</u>	40 & 42	Marine Parade
1488 Agricultural/Horticultural Activities	Chemicals-Agricultural	Land-use	Not investigated	Commercial/Industrial		Marine Parade
1488 Agricultural/Horticultural Activities	Chemicals-Agricultural	Land-use	Not investigated	Commercial/Industrial	40 & 42	Marine Parade
1488 Agricultural/Horticultural Activities	Chemicals-Agricultural	Land-use	Not investigated	Commercial/Industrial	40 & 42	Marine Parade
1497		Land-use	Unverified HAIL	Commercial/Industrial		McDonald St
1508 Service Stations	Service Stations	Land-use	Not investigated	Commercial/Industrial	11	Paul Street
1508 Service Stations	Service Stations	Land-use	Not investigated	Commercial/Industrial	11	Paul Street
1508 Service Stations	Service Stations	Land-use	Not investigated	Commercial/Industrial	11	Paul Street
1513 Service Stations	Garages	Land-use	Not investigated	Commercial/Industrial	60	Marine Parade
1513 Service Stations	Garages	Land-use	Not investigated	Commercial/Industrial	60	Marine Parade
1513 Service Stations	Garages	Land-use	Not investigated  Not investigated	Commercial/Industrial	60	Marine Parade
1513 Service Stations 1513 Service Stations		Land-use Land-use	Not investigated  Not investigated	Commercial/Industrial	60	Marine Parade  Marine Parade
	Garages					
1515 Service Stations	Garages	Land-use	Partially investigated	Commercial/Industrial	54	Queen Street
1521 Oil Production and Storage	Petrol & Oil Companies	Land-use	Unverified HAIL	Commercial/Industrial		Railway Rd
1529 Airports	Airfields	Land-use	Hazardous substances acceptable for <land use=""></land>	Commercial/Industrial		Wairoa Aerodrome
1529 Airports	Airfields	Land-use	Hazardous substances acceptable for <land use=""></land>	Commercial/Industrial		Wairoa Aerodrome
1529 Airports	Airfields	Land-use	Hazardous substances acceptable for <land use=""></land>	Commercial/Industrial		Wairoa Aerodrome
1529 Airports	Airfields	Land-use	Hazardous substances acceptable for <land use=""></land>	Commercial/Industrial		Wairoa Aerodrome

SiteID SiteType	NZSIC_Description	ClassificationCategory	ClassificationSubCategory	LandUse	AddressRapid	AddressNo	AddressRoadName
1529 Airports	Airfields	Land-use	Hazardous substances acceptable for <land use=""></land>	Commercial/Industrial			Wairoa Aerodrome
1529 Airports	Airfields	Land-use	Hazardous substances acceptable for <land use=""></land>	Commercial/Industrial			Wairoa Aerodrome
1529 Airports	Airfields	Land-use	Hazardous substances acceptable for <land use=""></land>	Commercial/Industrial			Wairoa Aerodrome
1529 Airports	Airfields	Land-use	Hazardous substances acceptable for <land use=""></land>	Commercial/Industrial			Wairoa Aerodrome
1529 Airports	Airfields	Land-use	Hazardous substances acceptable for <land use=""></land>	Commercial/Industrial			Wairoa Aerodrome
1529 Airports	Airfields	Land-use	Hazardous substances acceptable for <land use=""></land>	Commercial/Industrial			Wairoa Aerodrome
1529 Airports	Airfields	Land-use	Hazardous substances acceptable for <land use=""></land>	Commercial/Industrial			Wairoa Aerodrome
1529 Airports	Airfields	Land-use	Hazardous substances acceptable for <land use=""></land>	Commercial/Industrial			Wairoa Aerodrome
1531 Landfill Sites	Landfills	Land-use	Not investigated	Commercial/Industrial			Wairoa Tip
1787	Underground Tanks Removed:	Land-use	Hazardous substances acceptable for <land use=""></land>	Commercial/Industrial		51	Carroll Street
1799		Land-use	Partially investigated	Commercial/Industrial			
1805		Land-use	Hazardous substances acceptable for <land use=""></land>	Commercial/Industrial			Kaimoana Road
1841 Wood Treatment and Preservation	Timber Preservation	Land-use	Partially investigated	Commercial/Industrial		159	Carroll Street
1844 Wood Treatment and Preservation	Timber Preservation	Land-use	Partially investigated	Commercial/Industrial		37	Mitchell Road
1844 Wood Treatment and Preservation	Timber Preservation	Land-use	Partially investigated	Commercial/Industrial		37	Mitchell Road
1845		Land-use	Not investigated	Commercial/Industrial			State Highway 2
1864 Landfill Sites	Landfills	Land-use	Partially investigated	Commercial/Industrial			Main Rd North
1865 Landfill Sites	Landfills	Land-use	Partially investigated	Commercial/Industrial			Main North Rd
1906 Agricultural/Horticultural Activities	Meat Slaughtering	Land-use	Not investigated	Commercial/Industrial			Frasertown Road
1907 Scrap Yards	Scrap Metal Merchants	Land-use	Not investigated	Residential			
1910 Agricultural/Horticultural Activities	Chemicals-Agricultural	Land-use	Not investigated	Agricultural			Paul St
1911 Service Stations	Panel-Beaters & Motor Body Builders	Land-use	Not investigated	Commercial/Industrial			Carroll St
2272 Miscellaneous	Forestry	Land-use	Not investigated	Commercial/Industrial		40	Willowflat Road
2272 Miscellaneous	Forestry	Land-use	Not investigated	Commercial/Industrial		40	Willowflat Road
2280 Engineering	Earthmoving/Transport Contractor	Land-use	Hazardous substances acceptable for <land use=""></land>	Commercial/Industrial		3221	State Highway 2
2290	Storage	Land-use	Not investigated				Freyburg Street
2292		Land-use	Not investigated			4169	Lake Road, Lake Waikaremoana
2293	Storage	Land-use	Not investigated				Lake Waikaremoana
2307 Miscellaneous	Printing Co	Land-use	Not investigated	Commercial/Industrial		75	Queen St
2307 Miscellaneous	Printing Co	Land-use	Not investigated	Commercial/Industrial		75	Queen St

AddressLocality	TerritorialAuthority	SiteFullAddress	OccupierID OccupierName	OwnerID OwnerName
	Wairoa		843 Kiwi Transport Co Ltd	OwnerD OwnerName
Frasertown		12 Frasertown Road, SH 38, Frasertown, Wairoa		
Kaitawa Kaitawa	Wairoa Wairoa	Kaitawa Hydro Power Stn, SH 38, Kaitawa, Wairoa  Kaitawa Hydro Power Stn, SH 38, Kaitawa, Wairoa	434 Electricorp 434 Electricorp	
			•	
Kaitawa	Wairoa	Kaitawa Hydro Power Stn, SH 38, Kaitawa, Wairoa	434 Electricorp	
Kaitawa Kaitawa	Wairoa Wairoa	Kaitawa Hydro Power Stn, SH 38, Kaitawa, Wairoa Kaitawa Hydro Power Stn, SH 38, Kaitawa, Wairoa	434 Electricorp	
Kaitawa	Wairoa		434 Electricorp	
Kaitawa	Wairoa	Kaitawa Hydro Power Stn, SH 38, Kaitawa, Wairoa  Kaitawa Hydro Power Stn, SH 38, Kaitawa, Wairoa	434 Electricorp 434 Electricorp	
Kaitawa	Wairoa			
Kaitawa	Wairoa	Kaitawa Hydro Power Stn, SH 38, Kaitawa, Wairoa  Kaitawa Tip, Kaitawa, Wairoa	434 Electricorp 1557 Urewera Park Board	
Mahia	Wairoa	Mahia Beach Tip, Mahia, Wairoa	1611 Wairoa County & District	
North Clyde	Wairoa	13 Bridge St, North Clyde, Wairoa	357 De Luxe Ford	
	Wairoa		357 De Luxe Ford	
North Clyde North Clyde	Wairoa	13 Bridge St, North Clyde, Wairoa	357 De Luxe Ford 357 De Luxe Ford	
North Clyde	Wairoa	13 Bridge St, North Clyde, Wairoa	357 De Luxe Ford	
North Clyde	Wairoa	13 Bridge St, North Clyde, Wairoa  Carroll St, North Clyde, Wairoa	1818 Clyde Lumber Company	
North Clyde	Wairoa	Carroll St, North Clyde, Wairoa	1818 Clyde Lumber Company	
North Clyde	Wairoa	Carroll St, North Clyde, Wairoa	1818 Clyde Lumber Company	
North Clyde	Wairoa			
North Clyde	Wairoa	Carroll St, North Clyde, Wairoa Carroll St, North Clyde, Wairoa	1818 Clyde Lumber Company 1818 Clyde Lumber Company	
North Clyde	Wairoa	Carroll St, North Clyde, Wairoa	1818 Clyde Lumber Company  1818 Clyde Lumber Company	
North Clyde	Wairoa	Carroll St, North Clyde, Wairoa  Carroll St, North Clyde, Wairoa	1818 Clyde Lumber Company  1818 Clyde Lumber Company	
North Clyde	Wairoa	145 Carroll Street, North Clyde, Wairoa	409 Drager C L & Sons Ltd	409 Drager C L & Sons Ltd
North Clyde	Wairoa	145 Carroll Street, North Clyde, Wairoa	409 Drager C L & Sons Ltd	409 Drager C L & Sons Ltd
North Clyde	Wairoa	55 Carroll St, North Clyde, Wairoa	1638 WDC	409 Diagei C L & 30113 Ltu
North Clyde	Wairoa	55 Carroll St, North Clyde, Wairoa	1638 WDC	
North Clyde	Wairoa	2 McDonald Street, North Clyde, Wairoa	244 Carter Holt Building Supplies	
North Clyde	Wairoa	2 McDonald Street, North Clyde, Wairoa	244 Carter Holt Building Supplies	
Nuhaka	Wairoa	127 Blucks Pitt Rd, Nuhaka, Wairoa	162 Blucks Pit	
Nuhaka	Wairoa	127 Blucks Pitt Rd, Nuhaka, Wairoa	162 Blucks Pit	
Nuhaka	Wairoa	127 Blucks Pitt Rd, Nuhaka, Wairoa	162 Blucks Pit	
Nuhaka	Wairoa	127 Blucks Pitt Rd. Nuhaka, Wairoa	162 Blucks Pit	
Nuhaka	Wairoa	127 Blucks Pitt Rd, Nuhaka, Wairoa	162 Blucks Pit	
Nuhaka	Wairoa	127 Blucks Pitt Rd, Nuhaka, Wairoa	162 Blucks Pit	
Nuhaka	Wairoa	127 Blucks Pitt Rd, Nuhaka, Wairoa	162 Blucks Pit	
Nuhaka	Wairoa	127 Blucks Pitt Rd, Nuhaka, Wairoa	162 Blucks Pit	
Nuhaka	Wairoa	127 Blucks Pitt Rd, Nuhaka, Wairoa	162 Blucks Pit	
Nuhaka	Wairoa	127 Blucks Pitt Rd, Nuhaka, Wairoa	162 Blucks Pit	
Nuhaka	Wairoa	Main Road. RD 8, Nuhaka, Wairoa	2190 Nuhaka Garage	
Nuhaka	Wairoa	Main Road, RD 8, Nuhaka, Wairoa	2190 Nuhaka Garage	
Nuhaka	Wairoa	State Highway 2, Nuhaka, Wairoa	1086 Nuhaka Store Ltd	
Opoutama	Wairoa	1484 Nuhaka Opoutama Road, Opoutama, Wairoa	505 Fosters Service Station	
Opoutama	Wairoa	1484 Nuhaka Opoutama Road, Opoutama, Wairoa	505 Fosters Service Station	
Piripaua	Wairoa	4488 Piripaua Hydro Power Stn, SH 38, Piripaua, Wairoa	434 Electricorp	
Piripaua	Wairoa	4488 Piripaua Hydro Power Stn, SH 38, Piripaua, Wairoa	434 Electricorp	
Piripaua	Wairoa	4488 Piripaua Hydro Power Stn, SH 38, Piripaua, Wairoa	434 Electricorp	
Raupunga	Wairoa	State Highway 2 , Raupunga, Wairoa	1263 Raupunga Store	
Tuai	Wairoa	Tuai Hydro Power Stn, Tuai, Wairoa	435 Electricorp Waihi (Wairoa Power Co)	
Tuai	Wairoa	Tuai Hydro Power Stn, Tuai, Wairoa	435 Electricorp Waihi (Wairoa Power Co)	
Tuai	Wairoa	Tuai Hydro Power Stn, Tuai, Wairoa	435 Electricorp Waihi (Wairoa Power Co)	
Tuai	Wairoa	Tuai Hydro Power Stn, Tuai, Wairoa	435 Electricorp Waihi (Wairoa Power Co)	
Tuai	Wairoa	Tuai Hydro Power Stn, Tuai, Wairoa	435 Electricorp Waihi (Wairoa Power Co)	
Tuai	Wairoa	Tuai Hydro Power Stn, Tuai, Wairoa	435 Electricorp Waihi (Wairoa Power Co)	
Tuai	Wairoa	Tuai Hydro Power Stn, Tuai, Wairoa	435 Electricorp Waihi (Wairoa Power Co)	
Tuai	Wairoa	Tuai Hydro Power Stn, Tuai, Wairoa	435 Electricorp Waini (Wairoa Power Co)	
Tuai	Wairoa	Tuai Hydro Power Stn, Tuai, Wairoa	435 Electricorp Waihi (Wairoa Power Co)	
Tuai	Wairoa	Tuai Hydro Power Stn, Tuai, Wairoa	435 Electricorp Waihi (Wairoa Power Co)	
Tuai	Wairoa	Tuai Hydro Power Stn, Tuai, Wairoa	435 Electricorp Waihi (Wairoa Power Co)	
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A delegand and the	Tamika dalam da da	Cia-Culla delucci	Ossaria ID Ossaria Nova	Owner ID Owner Name
AddressLocality Tuai	Territorial Authority Wairoa	SiteFullAddress Tuni Hudes Power Sto. Tuni Wairen	OccupierID OccupierName 435 Electricorp Waihi (Wairoa Power Co)	OwnerID OwnerName
		Tuai Hydro Power Stn, Tuai, Wairoa		
Tuai	Wairoa	Tuai Hydro Power Stn, Tuai, Wairoa	435 Electricorp Waihi (Wairoa Power Co)	
Гиаі Гиаі	Wairoa	Tuai Hydro Power Stn, Tuai, Wairoa	435 Electricorp Waihi (Wairoa Power Co) 435 Electricorp Waihi (Wairoa Power Co)	
	Wairoa	Tuai Hydro Power Stn, Tuai, Wairoa		
Tuai Tuai	Wairoa Wairoa	Tuai Hydro Power Stn, Tuai, Wairoa	435 Electricorp Waihi (Wairoa Power Co) 435 Electricorp Waihi (Wairoa Power Co)	
		Tuai Hydro Power Stn, Tuai, Wairoa		
Tuai Tuai	Wairoa Wairoa	Tuai Hydro Power Stn, Tuai, Wairoa Tuai Hydro Power Stn, Tuai, Wairoa	435 Electricorp Waihi (Wairoa Power Co) 435 Electricorp Waihi (Wairoa Power Co)	
Tuai	Wairoa	Tuai Hydro Power Stn, Tuai, Wairoa Tuai Hydro Power Stn, Tuai, Wairoa	435 Electricorp Walni (Walroa Power Co)  435 Electricorp Walni (Walroa Power Co)	
Tuai	Wairoa	<u> </u>		
Tuai	Wairoa	Tuai Hydro Power Stn, Tuai, Wairoa Tuai Hydro Power Stn, Tuai, Wairoa	435 Electricorp Waihi (Wairoa Power Co) 435 Electricorp Waihi (Wairoa Power Co)	
Tuai	Wairoa	<u> </u>		
Tuai	Wairoa	Tuai Hydro Power Stn, Tuai, Wairoa Tuai Hydro Power Stn, Tuai, Wairoa	435 Electricorp Waihi (Wairoa Power Co) 435 Electricorp Waihi (Wairoa Power Co)	
Tuai	Wairoa	Tuai Hydro Power Stn, Tuai, Wairoa Tuai Hydro Power Stn, Tuai, Wairoa	435 Electricorp Walni (Walroa Power Co)  436 Electricorp Walni (Walroa Power Co)	
Tuai	Wairoa	Tuai Hydro Power Stn, Tuai, Wairoa	435 Electricorp Waini (Wairoa Power Co)	
Tuai	Wairoa	Tuai Tip, Tuai, Wairoa	446 Energy	
Waikokopu	Wairoa	Waikokopu, Waikokopu, Wairoa	1576 Waikokopu Wharf	
Waikokopu	Wairoa	Waikokopu, Waikokopu, Wairoa	1576 Walkokopu Wharf	
Wairoa	Wairoa	203 Awamate Rd, Wairoa, Wairoa	1566 Venex Ltd	
Wairoa	Wairoa	111 Clyde Rd, Wairoa, Wairoa	2189 C Chamberlain & K Wallace	
Wairoa	Wairoa	80 Hunterbrown St, Wairoa, Wairoa	18 Affco NZ Ltd	
Wairoa	Wairoa	80 Hunterbrown St, Wairoa, Wairoa	18 Affco NZ Ltd	
Wairoa	Wairoa	80 Hunterbrown St, Wairoa, Wairoa	18 Affco NZ Ltd	
Wairoa	Wairoa	80 Hunterbrown St, Wairoa, Wairoa	18 Affco NZ Ltd	
Wairoa	Wairoa	80 Hunterbrown St, Wairoa, Wairoa 80 Hunterbrown St, Wairoa, Wairoa	18 Affco NZ Ltd	
Wairoa	Wairoa	80 Hunterbrown St, Wairoa, Wairoa	18 Affco NZ Ltd	
Wairoa	Wairoa	80 Hunterbrown St, Wairoa, Wairoa	18 Affco NZ Ltd	
Wairoa	Wairoa	80 Hunterbrown St, Wairoa, Wairoa	18 Affico NZ Ltd	
Wairoa	Wairoa	80 Hunterbrown St, Wairoa, Wairoa	18 Affco NZ Ltd	
Wairoa	Wairoa	80 Hunterbrown St. Wairoa, Wairoa	18 Affco NZ Ltd	
Wairoa	Wairoa	80 Hunterbrown St, Wairoa, Wairoa	18 Affco NZ Ltd	
Wairoa	Wairoa	Kaimoana Rd, Wairoa, Wairoa	1266 Ravensdown Fertiliser Co-op Ltd	
Wairoa	Wairoa	Kaumoana Rd, Wairoa, Wairoa	1108 NZ Rail	
Wairoa	Wairoa	3 Archilles Street, Wairoa, Wairoa	2187 Eastland Tyres Ltd T/A The Tyre General	
Wairoa	Wairoa	3 Archilles Street, Wairoa, Wairoa	2187 Eastland Tyres Ltd T/A The Tyre General	
Wairoa	Wairoa	3 Archilles Street, Wairoa, Wairoa	2187 Eastland Tyres Ltd T/A The Tyre General	
Wairoa	Wairoa	Cnr Lucknow St and Achilles Street/SH2, Wairoa, Wairoa	1604 Wairoa Autobodies Ltd	
Wairoa	Wairoa	Marine Parade, Wairoa, Wairoa	1615 Wairoa Power Co.	
Wairoa	Wairoa	40 & 42 Marine Parade, Wairoa, Wairoa	1671 Williams & Kettle Ltd	
Wairoa	Wairoa	40 & 42 Marine Parade, Wairoa, Wairoa	1671 Williams & Kettle Ltd	
Wairoa	Wairoa	40 & 42 Marine Parade, Wairoa, Wairoa	1671 Williams & Kettle Ltd	
Wairoa	Wairoa	40 & 42 Marine Parade, Wairoa, Wairoa	1671 Williams & Kettle Ltd	
Wairoa	Wairoa	40 & 42 Marine Parade, Wairoa, Wairoa	1671 Williams & Kettle Ltd	
Wairoa	Wairoa	McDonald St, Wairoa, Wairoa	1331 Russel Corp Ltd	
Wairoa	Wairoa	11 Paul Street, Wairoa, Wairoa	161 Bloggs Wairoa Toyota	
Wairoa	Wairoa	11 Paul Street, Wairoa, Wairoa	161 Bloggs Wairoa Toyota	
Wairoa	Wairoa	11 Paul Street, Wairoa, Wairoa	161 Bloggs Wairoa Toyota	
Wairoa	Wairoa	60 Marine Parade, Wairoa, Wairoa	1608 Wairoa Club (SH2)	
Wairoa	Wairoa	60 Marine Parade, Wairoa, Wairoa	1608 Wairoa Club (SH2)	
Wairoa	Wairoa	54 Queen Street, Wairoa, Wairoa	285 Chris Joblin Motors Ltd	
Wairoa	Wairoa	Railway Rd, Wairoa, Wairoa	529 Fulton Hogan	
Wairoa	Wairoa	Wairoa Aerodrome, Wairoa, Wairoa	1602 Wairoa Airfield	
Wairoa	Wairoa	Wairoa Aerodrome, Wairoa, Wairoa	1602 Wairoa Airfield	
Wairoa	Wairoa	Wairoa Aerodrome, Wairoa, Wairoa	1602 Wairoa Airfield	
Wairoa	Wairoa	Wairoa Aerodrome, Wairoa, Wairoa	1602 Wairoa Airfield	

AddressLocality	TerritorialAuthority	SiteFullAddress	OccupierID OccupierName	OwnerID OwnerName
Wairoa	Wairoa	Wairoa Aerodrome, Wairoa, Wairoa	1602 Wairoa Airfield	
Wairoa	Wairoa	Wairoa Aerodrome, Wairoa, Wairoa	1602 Wairoa Airfield	
Wairoa	Wairoa	Wairoa Aerodrome, Wairoa, Wairoa	1602 Wairoa Airfield	
Wairoa	Wairoa	Wairoa Aerodrome, Wairoa, Wairoa	1602 Wairoa Airfield	
Wairoa	Wairoa	Wairoa Aerodrome, Wairoa, Wairoa	1602 Wairoa Airfield	
Wairoa	Wairoa	Wairoa Aerodrome, Wairoa, Wairoa	1602 Wairoa Airfield	
Wairoa	Wairoa	Wairoa Aerodrome, Wairoa, Wairoa	1602 Wairoa Airfield	
Wairoa	Wairoa	Wairoa Aerodrome, Wairoa, Wairoa	1602 Wairoa Airfield	
Wairoa	Wairoa	Wairoa Tip, Wairoa, Wairoa	1606 Wairoa Borough & District	
Wairoa	Wairoa	51 Carroll Street, Wairoa, Wairoa	12 Adams Engineering	12 Adams Engineering
Nuhaka		, Nuhaka	1725 Church of Latter Day Saints	
Wairoa	Wairoa	Kaimoana Road, Wairoa, Wairoa	1728 Quality Roading Services Wairoa	
Wairoa	Wairoa	159 Carroll Street, Wairoa, Wairoa	2236 East Coast Lumber Co Ltd	2235 East Coast Lumber Co. Ltd
Wairoa	Wairoa	37 Mitchell Road, Wairoa, Wairoa	1755 Former Timber Treatment Site	
Wairoa	Wairoa	37 Mitchell Road, Wairoa, Wairoa	1755 Former Timber Treatment Site	
Nuhaka		State Highway 2, Nuhaka	1756 BP Oil Tank Spill, Nuhaka	
		Main Rd North	1775 The Beacons- Closed Landfill	1044 Napier City Council
		Main North Rd	1776 North Beacons- Closed Landfill	1044 Napier City Council
Frasertown	Wairoa	Frasertown Road, Frasertown, Wairoa	516 Frazertown Meat Co.	
			306 Clyde Auto Dismantlers	
Wairoa	Wairoa	Paul St, Wairoa, Wairoa	1703 Wrightson NMA Ltd	
Wairoa	Wairoa	Carroll St, Wairoa, Wairoa	1079 North Clyde Panel & Paint Ltd	
Mohaka	Wairoa	40 Willowflat Road, Mohaka, Wairoa	1159 Pan Pacific Ltd	1159 Pan Pacific Ltd
Mohaka	Wairoa	40 Willowflat Road, Mohaka, Wairoa	1159 Pan Pacific Ltd	1159 Pan Pacific Ltd
Nuhaka	Wairoa	3221 State Highway 2, Nuhaka, Wairoa	2208 Quality Roading and Services Ltd	
Wairoa	Wairoa	Freyburg Street, Wairoa, Wairoa	670 Hawke's Bay Regional Council	
Wairoa	Wairoa	4169 Lake Road, Lake Waikaremoana, Wairoa, Wairoa	2231 Department of Conservattion	
Wairoa	Wairoa	Lake Waikaremoana, Wairoa, Wairoa	2225 Department of Conservation	
Wairoa	Wairoa	75 Queen St, Wairoa, Wairoa	2262 Wairoa Star	
Wairoa	Wairoa	75 Queen St, Wairoa, Wairoa	2262 Wairoa Star	

Archive HasLegal	Parcel_ID	LegalDescription	ValuationID	PhysicalLocation	OccName1	OccName2
0 Verified	4117309	LOT 1 DP 5357	0878000302	12 FRASERTOWN ROAD, WAIROA	Kiwi Transport Co Ltd	
0 Unverified	Unknown	SEC 10 BLK I WAIAU SD	Unknown			
0 Unverified	Unknown	SEC 9 BLK I WAIAU SD	Unknown			
0 Unverified	Unknown	Unknown	0876003705	0 STATE HIGHWAY 38, WAIROA	Conservation Department	
0 Unverified	Unknown	Unknown	0876004000	4707 STATE HIGHWAY 38, WAIROA	Hodge Phillip Jon	Hodge Laura Anna
0 Verified	4115842	PT SEC 1 BLK III WAIAU SD	Unknown	•		
0 Verified	4117864	PT SEC 5 BLK III WAIAU SD	Unknown			
0 Verified	4138643	SEC 7 BLK I WAIAU SD	Unknown			
0 Verified	4147577	SEC 8 BLK I WAIAU SD	Unknown			
0 None	-					
0 Verified	4181183	LOT 40 DP 11480	0870050836	0 ORMOND DRIVE, WAIROA	The Owners	
0 Verified	4172988	LOT 23 DP 1413	0885025200	7-13 BRIDGE STREET, WAIROA	Vish Holding Limited	
0 Verified	4194474	LOT 24 DP 1413	0885025200	7-13 BRIDGE STREET, WAIROA	Vish Holding Limited	
0 Verified	4194863	PT LOT 21 DP 1413	0885025200	7-13 BRIDGE STREET, WAIROA	Vish Holding Limited	
0 Verified	4194883	PT LOT 22 DP 1413	0885025200	7-13 BRIDGE STREET, WAIROA	Vish Holding Limited	
0 Unverified	Unknown	LOT 16 DP 6847	Unknown	7 13 BRIDGE STREET, WARROA	VISIT FIOREITS ENTITED	
0 Unverified	Unknown	LOT 17 DP 6847	Unknown			
0 Unverified	Unknown	LOT 18 DP 6847	Unknown			
0 Unverified	Unknown	LOT 19 DP 6847	Unknown			
0 Unverified	Unknown	LOT 2 DP 21632	Unknown			
0 Unverified 0 Unverified	Unknown Unknown	LOT 21 DP 6847  MBLK 12E3 ORANGITIROHIA	Unknown Unknown			
0 Verified	4242462	LOT 3 DP 18324	0885004100	145 CARROLL STREET, WAIROA	Danner Heldinger Hed	
					Drager Holdings Ltd	
0 Verified	4242461	LOT 1 DP 7306	0885004000	107 CARROLL STREET, WAIROA	Drager Holdings Ltd	
0 Unverified	Unknown	LOT 1 DP 19452	Unknown			
0 Unverified	Unknown	LOT 1 DP 21632	Unknown			
0 Verified	4160730	PT LOT 43 DP 1583	0885005800	0 FREYBERG STREET,WAIROA	Carters Holt Harvey Limited	
0 Verified	4225704	PT LOT 43 DP 1583	0885005800	0 FREYBERG STREET, WAIROA	Carters Holt Harvey Limited	
0 Verified	4160183	PT LOT 44 DP 1583	0885005800	0 FREYBERG STREET, WAIROA	Carters Holt Harvey Limited	
0 Verified	4160290	PT LOT 5 DP 3780	0885005900	2 MACDONALD STREET, WAIROA	Carters Holt Harvey Limited	
0 Verified	4225183	PT LOT 6 DP 3780	0885005900	2 MACDONALD STREET, WAIROA	Carters Holt Harvey Limited	
0 Verified	4203359	PT LOT 7 DP 3780	0885005900	2 MACDONALD STREET, WAIROA	Carters Holt Harvey Limited	
0 Verified	4225396	PT LOT 1 DP 3780	0885005900	2 MACDONALD STREET, WAIROA	Carters Holt Harvey Limited	
0 Verified	4181979	PT LOT 2 DP 3780	0885005900	2 MACDONALD STREET, WAIROA	Carters Holt Harvey Limited	
0 Verified	4203063	PT LOT 3 DP 3780	0885005900	2 MACDONALD STREET, WAIROA	Carters Holt Harvey Limited	
0 Verified	4224600	PT LOT 4 DP 3780	0885005900	2 MACDONALD STREET, WAIROA	Carters Holt Harvey Limited	
0 Verified	4159642	PT SEC 4 SO 950	0872023600	0 STATE HIGHWAY 2 NORTH, WAIROA	Wairoa District Council	
0 Verified	4239520	PT SEC 4 SO 950	0872023600	0 STATE HIGHWAY 2 NORTH, WAIROA	Wairoa District Council	
0 Unverified	Unknown	PT MBLK 244A1B NUHAKA	Unknown			
0 Unverified	Unknown	PT MBLK 2A4A1C NUHAKA	Unknown			
0 Unverified	Unknown	PT MBLK 2A4A1C1 NUHAKA	Unknown			
0 Unverified	Unknown	PT MBLK 2C2J NUHAKA	Unknown			
0 Unverified	Unknown	PT MBLK 2C2K NUHAKA	Unknown			
0 Unverified	Unknown	PT MBLK 2C2L NUHAKA	Unknown			
0 Unverified	Unknown	PT MBLK 2C2L1 NUHAKA	Unknown			
0 Unverified	Unknown	PT MBLK 2C2L2 NUHAKA	Unknown			
0 Verified	4229055	Lot 1 DP 4481	0872025300	0 STATE HIGHWAY 2 NORTH, WAIROA	Michaelsen Richard Layton	Michaelsen Peke Maharatanga
0 Verified	4207496	X1B Nuhaka	0872025400	0 STATE HIGHWAY 2 NORTH, WAIROA	Michaelsen Richard Layton	
0 None						
0 Unverified	Unknown	Unknown	0870013800	1484 OPOUTAMA RD,WAIROA	Fosters Buses (2005) Limited	
0 Verified	4191614	SEC 33 BLK III MAHANGA SD	Unknown			
0 Verified	4145463	PT MBLK 2 HEIOTAHOKA	Unknown			
0 Unverified	Unknown	PT SEC 2 BLK IV WAIAU SD	Unknown			
0 Unverified	Unknown	Unknown	0876005400	4488 S HWAY 38,WAIROA	Heiotahoka 2B, Te Kopani 36 & 37 Trustee	
0 None						
0 Unverified	Unknown	LOT 15 DP 7900	Unknown			
0 Unverified	Unknown	LOT 20 DP 7900	Unknown			
0 Unverified	Unknown	LOT 30 DP 7900	Unknown			
0 Unverified	Unknown	LOT 38 DP 7900	Unknown			
0 Unverified	Unknown	LOT 40 DP 7900	Unknown			
0 Unverified	Unknown	LOT 42 DP 7900	Unknown			
0 Unverified	Unknown	LOT 44 DP 7900	Unknown			
0 Unverified	Unknown	LOT 51 DP 7900	Unknown			
0 Unverified	Unknown	LOT 55 DP 7900	Unknown			
0 Unverified	Unknown	PT SEC 1 OF 5 BLK IV WAIAU SD	Unknown			
0 Unverified	Unknown	PT SEC 14 BLK IV WAIAU SD	Unknown			
		* *				

Archive	nal Park Board nal Park Board Gilbert Monehu Heni  uncil e I uncil Coastvet Limited
0 Unverified         Unknown         SEC 13 BLK IV WAIAU SD         Unknown           0 Unverified         Unknown         SEC 15 BLK IV WAIAU SD         Unknown           0 Unverified         Unknown         0 Urverified         Unknown         0 Urverified           0 Verified         4135581         Pt Manuoha         0 876001800         6395 STATE HIGHWAY 38,WAIROA         Te Urveera Natior           0 Verified         4137685         Dt Manual Manu	nal Park Board nal Park Board Gilbert Monehu Heni  uncil e I uncil Coastvet Limited
0 Unverified         Unknown         SEC 15 BLK IV WAIAU SD         Unknown           0 Unverified         Unknown         Unknown         0876001800         6395 STATE HIGHWAY 38, WAIROA         Te Urewera Nation           0 Verified         4135581         Pt Manunaha         0876001800         6395 STATE HIGHWAY 38, WAIROA         Te Urewera Nation           0 Verified         4137685         LOT 5 DP 7989         0876005906         41 VALLEY ROAD, WAIROA         Gilbert Hurae           0 Verified         4128249         LOT 10 DP 7989         0876005911         36 VALLEY ROAD, WAIROA         Dawick lan John           0 Verified         4115677         LOT 93 DP 7989         0876005911         34 VALLEY ROAD, WAIROA         Dawick lan John           0 Verified         4116840         LOT 90 DP 7991         0876005914         34 VALLEY ROAD, WAIROA         Wairoa District Co           0 Verified         4116810         LOT 72 DP 7991         0876005965         0 TUAI MAIN ROAD, WAIROA         Talyine Ioseph           0 Verified         4116810         LOT 72 DP 7991         0876005987         3 ROTTEN ROW, WAIROA         Talyine Ioseph           0 Verified         4128229         LOT 60 DP 7991         0876005982         0 WAIKARE-TAHEKE STREET, WAIROA         Genesis Power Ltd           0 Verified	nal Park Board nal Park Board Gilbert Monehu Heni  uncil e I uncil Coastvet Limited
0 Unverified         Unknown         Unknown         0876001800         6395 STATE HIGHWAY 38,WAIROA         Te Urewera Natior           0 Verified         4135551         Pt Manucha         0876001800         6395 STATE HIGHWAY 38,WAIROA         Te Urewera Natior           0 Verified         4113850         Pt Maungapohatu         0876001800         6395 STATE HIGHWAY 38,WAIROA         Te Urewera Natior           0 Verified         4137685         LOT 5 DP 7989         0876005906         41 VALLEY ROAD,WAIROA         Gilbert Hurae           0 Verified         4128249         LOT 10 DP 7989         0876005911         36 VALLEY ROAD,WAIROA         Dawick lan John           0 Verified         4115377         LOT 93 DP 7989         0876005951         34 VALLEY ROAD,WAIROA         Dawick lan John           0 Verified         4116840         LOT 90 DP 7991         0876005965         0 TUAI MAIN ROAD,WAIROA         Tuainien Joseph           0 Verified         4115600         LOT 74 DP 7991         0876005980         1 ROTTEN ROW,WAIROA         Tuainien Joseph           0 Verified         4128229         LOT 60 DP 7991         0876005980         1 ROTTEN ROW,WAIROA         Taylor Neal George           0 Verified         4128229         LOT 60 DP 7991         0876005982         0 WAIKOKOPU ROAD,WAIROA         Various	nal Park Board nal Park Board Gilbert Monehu Heni  uncil e I uncil Coastvet Limited
0 Verified         4135581         Pt Manuoha         0876001800         6395 STATE HIGHWAY 38,WAIROA         Te Urewera Nation           0 Verified         4113850         Pt Maungapohatu         0876001800         6395 STATE HIGHWAY 38,WAIROA         Te Urewera Nation           0 Verified         4137685         LOT 5 DP 7989         0876005906         41 VALLEY ROAD,WAIROA         Dawick lan John           0 Verified         4128249         LOT 10 DP 7989         0876005914         34 VALLEY ROAD,WAIROA         Dawick lan John           0 Verified         4115377         LOT 93 DP 7989         0876005914         34 VALLEY ROAD,WAIROA         Dawick lan John           0 Verified         4116840         LOT 90 DP 7991         0876005918         38 OTTEN ROW,WAIROA         Wairoa District Con           0 Verified         4116810         LOT 72 DP 7991         0876005983         3 ROTTEN ROW,WAIROA         Taylor Neal George           0 Verified         41128229         LOT 60 DP 7991         0876005980         1 ROTTEN ROW, WAIROA         Taylor Neal George           0 Verified         4128229         LOT 60 DP 7991         0876005980         1 ROTTEN ROW, WAIROA         Genesis Power Ltd           0 Verified         4128253         PT SEC 5 BLK IV WAIAU SD         Unknown         Unknown         Unknown <td>nal Park Board nal Park Board Gilbert Monehu Heni  uncil e I uncil Coastvet Limited</td>	nal Park Board nal Park Board Gilbert Monehu Heni  uncil e I uncil Coastvet Limited
0 Verified         4113850         Pt Maungapohatu         0876001800         6395 STATE HIGHWAY 38,WAIROA         Te Urewera Nation           0 Verified         4137685         LOT 5 DP 7899         0876005906         41 VALLEY ROAD,WAIROA         Gilbert Hurae           0 Verified         4128249         LOT 10 DP 7989         0876005911         36 VALLEY ROAD,WAIROA         Dawick lan John           0 Verified         4115877         LOT 30 DP 7999         0876005914         34 VALLEY ROAD,WAIROA         Dawick lan John           0 Verified         4116810         LOT 70 DP 7991         0876005978         3 ROTTEN ROW,WAIROA         Wairoa District Cor           0 Verified         4115600         LOT 74 DP 7991         0876005978         3 ROTTEN ROW,WAIROA         Taylor Neal George           0 Verified         4128229         LOT 60 DP 7991         0876005982         0 WAIKARE-TAHEKE STREET,WAIROA         Genesis Power Ltd           0 Verified         412553         PT SEC 5 BLK NWAIAU SD         Unknown           0 Verified         4145465         SEC 1 BLK XIX WAIKAREMOANA SD         Unknown           0 Verified         4219154         PT Sec 12 Blk X Nuhaka Survey District         0870010500         0 WAIKOKOPU ROAD,WAIROA         Various           0 Verified         4219154         PT Sec 12 Blk X Nuh	nal Park Board Gilbert Monehu Heni uncil e I uncil Coastvet Limited
0 Verified         4137685         LOT 5 DP 7989         0876005906         41 VALLEY ROAD,WAIROA         Gilbert Hurae           0 Verified         4128249         LOT 10 DP 7989         0876005911         36 VALLEY ROAD,WAIROA         Dawick lan John           0 Verified         4115377         LOT 30 DP 7989         0876005914         34 VALLEY ROAD,WAIROA         Dawick lan John           0 Verified         4116840         LOT 90 DP 7991         0876005965         0 TUAI MAIN ROAD,WAIROA         Wairoa District Co           0 Verified         4116810         LOT 72 DP 7991         0876005980         18 TOTTEN ROW,WAIROA         Tuahine Joseph           0 Verified         4128229         LOT 60 DP 7991         0876005980         18 TOTTEN ROW,WAIROA         Taylor Neal George           0 Verified         4128229         LOT 60 DP 7991         0876005980         18 TOTTEN ROW,WAIROA         Taylor Neal George           0 Verified         4128229         LOT 60 DP 7991         0876005982         0 WAIKARE-TAHEKE STREET,WAIROA         Genesis Power Ltd           0 Verified         4125533         PT SEC 5 BLK IX WAIKAREMOANA SD         Unknown         Unknown           0 Verified         4219154         Pt Sec 12 Blk X Nuhaka Survey District         0870010500         0 WAIKOKOPU ROAD,WAIROA         Wairoa District Co	Gilbert Monehu Heni uncil e I uncil uncil Coastvet Limited
0 Verified         4128249         LOT 10 DP 7989         0876005911         36 VALLEY ROAD,WAIROA         Dawick lan John           0 Verified         4115377         LOT 93 DP 7989         0876005965         34 VALLEY ROAD,WAIROA         Dawick lan John           0 Verified         4116840         LOT 90 DP 7991         0876005965         0 TUAI MAIN ROAD,WAIROA         Tuainier Joseph           0 Verified         4116810         LOT 72 DP 7991         0876005980         3 ROTTEN ROW,WAIROA         Tuainier Joseph           0 Verified         4128229         LOT 60 DP 7991         0876005980         1 ROTTEN ROW,WAIROA         Taylor Neal George           0 Verified         4128229         LOT 60 DP 7991         0876005980         0 WAIKARE-TAHEKE STREET,WAIROA         Genesis Power Ltd           0 Verified         4128229         LOT 60 DP 7991         0876005982         0 WAIKARE-TAHEKE STREET,WAIROA         Genesis Power Ltd           0 Verified         4128229         LOT 50 DP 7991         0876005982         0 WAIKARE-TAHEKE STREET,WAIROA         Genesis Power Ltd           0 Verified         41285533         PT SEC 5 BLK IV WAIAU SD         Unknown         Unknown           0 Verified         41249455         SEC 1 BLK XIX WAIKAREMOANA SD         Unknown         Unknown         Various         Various	uncil e I uncil Coastvet Limited
0 Verified         4115377         LOT 93 DP 7989         0876005914         34 VALLEY ROAD,WAIROA         Dawick lan John           0 Verified         4116840         LOT 90 DP 7991         0876005978         3 ROTTEN ROW,WAIROA         Wairoa District Cor           0 Verified         4115600         LOT 72 DP 7991         0876005978         3 ROTTEN ROW,WAIROA         Taylor Neal George           0 Verified         4128229         LOT 60 DP 7991         0876005982         0 WAIKARE-TAHEKE STREET,WAIROA         Genesis Power Ltd           0 Verified         4125553         PT SEC 5 BLK IV WAIAU SD         Unknown         Unknown           0 Verified         4145465         SEC 1 BLK XIX WAIKAREMOANA SD         Unknown           0 Verified         4219154         Pt Sec 12 Blk X Nuhaka Survey District         0870010500         0 WAIKOKOPU ROAD,WAIROA         Various           0 Verified         4219154         Pt Sec 12 Blk X Nuhaka Survey District         0870010500A         0 WAIKOKOPU ROAD,WAIROA         Wairoa District Cor           0 Verified         41279386         LOT 1 DP 22597         0878025196         203 AWAMATE ROAD,WAIROA         Hebron Ltd           0 Verified         4228229         LOT 1 DP 8388         088078600         111 CLYDE ROAD,WAIROA         Chamberlain Craig           0 Verified	e I uncil Coastvet Limited
0 Verified         4116840         LOT 90 DP 7991         0876005965         0 TUAI MAIN ROAD,WAIROA         Wairoa District Cor           0 Verified         4116810         LOT 72 DP 7991         0876005980         1 ROTTEN ROW,WAIROA         Tuahine Joseph           0 Verified         4115600         LOT 74 DP 7991         0876005980         1 ROTTEN ROW,WAIROA         Taylor Neal George           0 Verified         4128229         LOT 60 DP 7991         0876005982         0 WAIKARE-TAHEKE STREET,WAIROA         Genesis Power Ltd           0 Verified         4125553         PT SEC 5 BLK IX WAIKAREMOANA SD         Unknown           0 None         Unknown         Unknown         Verified           0 Verified         4219154         Pt Sec 12 Blk X Nuhaka Survey District         0870010500         0 WAIKOKOPU ROAD,WAIROA         Various           0 Verified         4219154         Pt Sec 12 Blk X Nuhaka Survey District         08700105000         0 WAIKOKOPU ROAD,WAIROA         Wairoa District Cor           0 Verified         4219154         Pt Sec 12 Blk X Nuhaka Survey District         08700105000         0 WAIKOKOPU ROAD,WAIROA         Wairoa District Cor           0 Verified         4229154         Pt Sec 12 Blk X Nuhaka Survey District         08700105000         0 WAIKOKOPU ROAD,WAIROA         Wairoa District Cor	e I uncil Coastvet Limited
0 Verified         4116810         LOT 72 DP 7991         0876005978         3 ROTTEN ROW,WAIROA         Tuahine Joseph           0 Verified         4115600         LOT 74 DP 7991         0876005980         1 ROTTEN ROW,WAIROA         Taylor Neal George           0 Verified         4128229         LOT 60 DP 7991         0876005982         0 WAIKARE-TAHEKE STREET,WAIROA         Genesis Power Ltd           0 Verified         4125553         PT SEC 5 BLK IV WAIAU SD         Unknown           0 Verified         4145465         SEC 1 BLK XIX WAIKAREMOANA SD         Unknown           0 Verified         4219154         PT Sec 12 Blk X Nuhaka Survey District         0870010500         0 WAIKOKOPU ROAD,WAIROA         Various           0 Verified         4219154         PT Sec 12 Blk X Nuhaka Survey District         0870010500         0 WAIKOKOPU ROAD,WAIROA         Wairoa District Co           0 Verified         4173986         LOT 1 DP 22597         0878025196         203 AWAMATE ROAD,WAIROA         Hebron Ltd           0 Verified         4228229         LOT 1 DP 8388         0888078600         111 CLYDE ROAD,WAIROA         Chamberlain Craig           0 Verified         4215268         LOT 1 DP 13699         0878053900         0 STATE HIGHWAY 2 NORTH,WAIROA         AFFCO New Zealar           0 Verified         4205942	e I uncil Coastvet Limited
0 Verified         4115600         LOT 74 DP 7991         0876005980         1 ROTTEN ROW, WAIROA         Taylor Neal George           0 Verified         4128229         LOT 60 DP 7991         0876005982         0 WAIKARE-TAHEKE STREET, WAIROA         Genesis Power Ltd           0 Verified         4125553         PT SEC 5 BLK IV WAIAU SD         Unknown           0 Verified         4145465         SEC 1 BLK XIX WAIKAREMOANA SD         Unknown           0 None         Verified         4219154         Pt Sec 12 Blk X Nuhaka Survey District         0870010500         0 WAIKOKOPU ROAD, WAIROA         Various           0 Verified         4219154         Pt Sec 12 Blk X Nuhaka Survey District         0870010500A         0 WAIKOKOPU ROAD, WAIROA         Wairoa District Co           0 Verified         4173986         LOT 1 DP 22597         0878025196         203 AWAMATE ROAD, WAIROA         Hebron Ltd           0 Verified         4228229         LOT 1 DP 3888         0888078600         111 CLYDE ROAD, WAIROA         Chamberlain Craig           0 Verified         4215268         LOT 1 DP 13699         0878054101         0 HUNTER-BROWN STREET, WAIROA         AFFCO New Zealar           0 Verified         4237744         LOT 2 DP 3183         0878053900         0 STATE HIGHWAY 2 NORTH, WAIROA         AFFCO New Zealar	uncil Coastvet Limited
0 Verified         4128229         LOT 60 DP 7991         0876005982         0 WAIKARE-TAHEKE STREET, WAIROA         Genesis Power Ltd           0 Verified         4125553         PT SEC 5 BLK IV WAIAU SD         Unknown           0 Verified         4145465         SEC 1 BLK XIX WAIKAREMOANA SD         Unknown           0 None         Verified         4219154         Pt Sec 12 BlK X Nuhaka Survey District         0870010500         0 WAIKOKOPU ROAD, WAIROA         Various           0 Verified         4219154         Pt Sec 12 BlK X Nuhaka Survey District         0870010500A         0 WAIKOKOPU ROAD, WAIROA         Wairoa District Co           0 Verified         4173986         LOT 1 DP 22597         0878025196         203 AWAMATE ROAD, WAIROA         Hebron Ltd           0 Verified         4228229         LOT 1 DP 3888         088078600         111 CLYDE ROAD, WAIROA         Chamberlain Craig           0 Verified         4215268         LOT 1 DP 13699         0878054101         0 HUNTER-BROWN STREET, WAIROA         AFFCO New Zealar           0 Verified         4237744         LOT 2 DP 3183         0878053900         0 STATE HIGHWAY 2 NORTH, WAIROA         AFFCO New Zealar           0 Verified         4205942         PT LOT 2 DP 3286         0878053900         0 STATE HIGHWAY 2 NORTH, WAIROA         AFFCO New Zealar	uncil Coastvet Limited
0 Verified         4125553         PT SEC 5 BLK IV WAIAU SD         Unknown           0 Verified         4145465         SEC 1 BLK XIX WAIKAREMOANA SD         Unknown           0 None         Verified         4219154         Pt Sec 12 Blk X Nuhaka Survey District         0870010500         0 WAIKOKOPU ROAD,WAIROA         Various           0 Verified         4219154         Pt Sec 12 Blk X Nuhaka Survey District         0870010500A         0 WAIKOKOPU ROAD,WAIROA         Wairoa District Cor           0 Verified         4173986         LOT 1 DP 22597         0878025196         203 AWAMATE ROAD,WAIROA         Hebron Ltd           0 Verified         4228229         LOT 1 DP 8388         0888078600         111 CLYDE ROAD,WAIROA         Chamberlain Craig           0 Verified         4215268         LOT 1 DP 13699         0878054101         0 HUNTER-BROWN STREET,WAIROA         AFFCO New Zealar           0 Verified         4237744         LOT 2 DP 3183         0878053900         0 STATE HIGHWAY 2 NORTH,WAIROA         AFFCO New Zealar           0 Verified         4205942         PT LOT 2 DP 3286         0878053900         0 STATE HIGHWAY 2 NORTH,WAIROA         AFFCO New Zealar	uncil Coastvet Limited
0 Verified         4145465         SEC 1 BLK XIX WAIKAREMOANA SD         Unknown           0 None         0 Verified         4219154         Pt Sec 12 Blk X Nuhaka Survey District         0870010500         0 WAIKOKOPU ROAD,WAIROA         Various           0 Verified         4219154         Pt Sec 12 Blk X Nuhaka Survey District         0870010500A         0 WAIKOKOPU ROAD,WAIROA         Wairoa District Cor           0 Verified         4173986         LOT 1 DP 22597         0878025196         203 AWAMATE ROAD,WAIROA         Hebron Ltd           0 Verified         4228229         LOT 1 DP 8388         0888078600         111 CLYDE ROAD,WAIROA         Chamberlain Craig           0 Verified         4215268         LOT 1 DP 13699         0878053401         0 HUNTER-BROWN STREET,WAIROA         AFFCO New Zealar           0 Verified         4237744         LOT 2 DP 3183         0878053900         0 STATE HIGHWAY 2 NORTH,WAIROA         AFFCO New Zealar           0 Verified         4205942         PT LOT 2 DP 3286         0878053900         0 STATE HIGHWAY 2 NORTH,WAIROA         AFFCO New Zealar	Coastvet Limited
0 None         0 Verified         4219154         Pt Sec 12 Blk X Nuhaka Survey District         0870010500         0 WAIKOKOPU ROAD,WAIROA         Various           0 Verified         4219154         Pt Sec 12 Blk X Nuhaka Survey District         0870010500A         0 WAIKOKOPU ROAD,WAIROA         Wairoa District Cor           0 Verified         4173986         LOT 1 DP 22597         0878025196         203 AWAMATE ROAD,WAIROA         Hebron Ltd           0 Verified         4228229         LOT 1 DP 8388         0888078600         111 CLYDE ROAD,WAIROA         Chamberlain Craig           0 Verified         4215268         LOT 1 DP 13699         0878054101         0 HUNTER-BROWN STREET,WAIROA         AFFCO New Zealar           0 Verified         42237744         LOT 2 DP 3183         0878053900         0 STATE HIGHWAY 2 NORTH,WAIROA         AFFCO New Zealar           0 Verified         4205942         PT LOT 2 DP 3286         0878053900         0 STATE HIGHWAY 2 NORTH,WAIROA         AFFCO New Zealar	Coastvet Limited
0 Verified         4219154         Pt Sec 12 Blk X Nuhaka Survey District         0870010500         0 WAIKOKOPU ROAD,WAIROA         Various           0 Verified         4219154         Pt Sec 12 Blk X Nuhaka Survey District         0870010500A         0 WAIKOKOPU ROAD,WAIROA         Wairoa District Cor           0 Verified         4173986         LOT 1 DP 22597         0878025196         203 AWAMATE ROAD,WAIROA         Hebron Ltd           0 Verified         4228229         LOT 1 DP 8388         0888078600         111 CLYDE ROAD,WAIROA         Chamberlain Craig           0 Verified         4215268         LOT 1 DP 13699         0878053101         0 HUNTER-BROWN STREET,WAIROA         AFFCO New Zealar           0 Verified         4237744         LOT 2 DP 3183         0878053900         0 STATE HIGHWAY 2 NORTH,WAIROA         AFFCO New Zealar           0 Verified         4205942         PT LOT 2 DP 3286         0878053900         0 STATE HIGHWAY 2 NORTH,WAIROA         AFFCO New Zealar	Coastvet Limited
0 Verified         4219154         Pt Sec 12 Blk X Nuhaka Survey District         0870010500A         0 WAIKOKOPU ROAD,WAIROA         Wairoa District Cor           0 Verified         4173986         LOT 1 DP 22597         0878025196         203 AWAMATE ROAD,WAIROA         Hebron Ltd           0 Verified         4228229         LOT 1 DP 8388         0888078600         111 CLYDE ROAD,WAIROA         Chamberlain Craig           0 Verified         4215268         LOT 1 DP 13699         0878053401         0 HUNTER-BROWN STREET,WAIROA         AFFCO New Zealar           0 Verified         4237744         LOT 2 DP 3183         0878053900         0 STATE HIGHWAY 2 NORTH,WAIROA         AFFCO New Zealar           0 Verified         4205942         PT LOT 2 DP 3286         0878053900         0 STATE HIGHWAY 2 NORTH,WAIROA         AFFCO New Zealar	Coastvet Limited
0 Verified         4173986         LOT 1 DP 22597         0878025196         203 AWAMATE ROAD,WAIROA         Hebron Ltd           0 Verified         4228229         LOT 1 DP 8388         0888078600         111 CLYDE ROAD,WAIROA         Chamberlain Craig           0 Verified         4215268         LOT 1 DP 13699         0878054101         0 HUNTER-BROWN STREET,WAIROA         AFFCO New Zealar           0 Verified         4237744         LOT 2 DP 3183         0878053900         0 STATE HIGHWAY 2 NORTH,WAIROA         AFFCO New Zealar           0 Verified         4205942         PT LOT 2 DP 3286         0878053900         0 STATE HIGHWAY 2 NORTH,WAIROA         AFFCO New Zealar	Coastvet Limited
0 Verified         4228229         LOT 1 DP 8388         0888078600         111 CLYDE ROAD,WAIROA         Chamberlain Craig           0 Verified         4215268         LOT 1 DP 13699         0878054101         0 HUNTER-BROWN STREET,WAIROA         AFFCO New Zealar           0 Verified         4237744         LOT 2 DP 3183         0878053900         0 STATE HIGHWAY 2 NORTH,WAIROA         AFFCO New Zealar           0 Verified         4205942         PT LOT 2 DP 3286         0878053900         0 STATE HIGHWAY 2 NORTH,WAIROA         AFFCO New Zealar	
0 Verified         4215268         LOT 1 DP 13699         0878054101         0 HUNTER-BROWN STREET,WAIROA         AFFCO New Zealar           0 Verified         4237744         LOT 2 DP 3183         0878053900         0 STATE HIGHWAY 2 NORTH,WAIROA         AFFCO New Zealar           0 Verified         4205942         PT LOT 2 DP 3286         0878053900         0 STATE HIGHWAY 2 NORTH,WAIROA         AFFCO New Zealar	
0 Verified         4237744         LOT 2 DP 3183         0878053900         0 STATE HIGHWAY 2 NORTH, WAIROA         AFFCO New Zealar           0 Verified         4205942         PT LOT 2 DP 3286         0878053900         0 STATE HIGHWAY 2 NORTH, WAIROA         AFFCO New Zealar	
0 Verified 4205942 PT LOT 2 DP 3286 0878053900 0 STATE HIGHWAY 2 NORTH, WAIROA AFFCO New Zealar	
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0 Verified 4220852 PLIOL2 DP 3286	
0 Verified 4213070 LOT 1 DP 3901 0878053900 0 STATE HIGHWAY 2 NORTH, WAIROA AFFCO New Zealar	
0 Verified 4179818 LOT 2 DP 13699 0878054100 0 HUNTER-BROWN STREET,WAIROA Affco New Zealand	1 Limited
0 Unverified Unknown SEC 10R BLK II CLYDE SD Unknown	
0 Unverified Unknown SEC 11R BLK II CLYDE SD Unknown	
0 Unverified Unknown SEC 12R BLK II CLYDE SD Unknown	
0 Unverified         Unknown         SEC 15 BLK II CLYDE SD         Unknown           0 Verified         4173367         LOT 2 DP 16841         Unknown	
0 None 0 None	
0 Verified 4225602 LOT 3 DP 1419 0888007100 3 ACHILLES STREET,WAIROA Bay Tyres 1996 Ltd	1
0 Verified 4223002 LOT 3 DF 1419 000000/100 3 ACHILLES 3 TREET, WARROA BBJ 1918 1990 LOT 0 Verified 4 4182200 PT LOT 1 DP 1419 008800/200 2 LAHORE STREET, WARROA Ottol Ltd	1
0 Verified 4.82200 F1 tO1 1D F1419 088807200 2 LAHORE STREET, WAIROA Ottol Ltd	
·	ert Gasson Denice Yvonne
0 Verified         4161395         LOT 7 DP 5366         0888000900         0 LUCKNOW STREET, WAIROA         Gasson Barry Robe           0 Verified         4209517         SEC 392 SO 9438         0887040800         173 KING STREET, WAIROA         Eastland Network	
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0 Unified 4188670 TNSEC 398 CLYDE SD Unknown	ngs Limited
0 Verified 4188002 TNSEC 399 CLYDE 5D Unknown	
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0 Verified 4236217 5 EC 150 9963 0887042000 60 MARINE PARADE,WAIROA Wairoa Club III.	
0 Verified 425027 SEC 250 9963 0887042000 0 MARINE PARADE, WAIROA Wairoa Club Inc.	
0 Verified 42185734 SEC 3 SO 9963 0887042000 60 MARINE PARADE,WAIROA Wairoa Club Inc.	
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Archive HasLegal	Parcel_ID	LegalDescription	ValuationID	PhysicalLocation	OccName1	OccName2
0 Unverified	Unknown	SEC 26 BLK I CLYDE SD	Unknown			
0 Unverified	Unknown	SEC 27 BLK I CLYDE SD	Unknown			
0 Verified	4181632	PT LOT 3 DP 6699	0878024100	78 AIRPORT ROAD, WAIROA	Clark Richard Stanley	Clark Rosemary Karen
0 Verified	4181755	PT LOT 3 DP 6699	0878024100	78 AIRPORT ROAD, WAIROA	Clark Richard Stanley	Clark Rosemary Karen
0 Verified	4165484	PT LOT 3 DP 5390	0878024200	85 AIRPORT ROAD, WAIROA	Wairoa District Council	
0 Verified	4182165	PT LOT 3 DP 5390	0878024200	85 AIRPORT ROAD, WAIROA	Wairoa District Council	
0 Verified	4182973	PT LOT 3 DP 5390	0878024200	85 AIRPORT ROAD, WAIROA	Wairoa District Council	
0 Verified	4203455	PT LOT 3 DP 5390	0878024200	85 AIRPORT ROAD, WAIROA	Wairoa District Council	
0 None						
0 Verified	4237737	Lot 6 DP 1174	0885028401	0 CARROLL STREET, WAIROA	Adams Hugh	Adams Ngaire
0 None						
0 None						
0 Verified	4183182	Lot 2 DP 28346	0885003401	161 CARROLL STREET, WAIROA	East Coast Lumber Property Ltd	
0 Verified	4232330	Lot 2 DP 24653	0890009500	118 ACHILLES STREET, WAIROA	Christian Revival Crusade Wairoa Inc	
0 Verified	4215433	Lot 3 DP 9068	0890009500	118 ACHILLES STREET, WAIROA	Christian Revival Crusade Wairoa Inc	
0 None						
0 None						
0 None						
0 None						
0 None						
0 None						
0 None						
0 Verified	4222677	LOT 1 DP 21899	0882000410	0 WILLOWFLAT ROAD, WAIROA	Pan Pac Forest Products Ltd	
0 Verified	4242680	LOT 1 DP 21991	0882000410	0 WILLOWFLAT ROAD, WAIROA	Pan Pac Forest Products Ltd	
0 None						
0 None						
0 None						
0 None						
0 Unverified	Unknown	Pt. Lot 13 DP 2695	0887046700	77 QUEEN STREET, WAIROA	Wairoa Star Ltd	
0 Unverified	Unknown	Pt. Lot 14 DP 2695	0887046700	77 QUEEN STREET, WAIROA	Wairoa Star Ltd	

OccAddr1	OccAddr2	OccAddr3
O Box 4	Frasertown	Wairoa
P O BOX 668	Gisborne	
4707 State Highway 38	RD 5	Wairoa
P O BOX 54	Wairoa	
	Wairoa Wairoa	
7-13 Bridge Street	Wairoa Wairoa	
7-13 Bridge Street 7-13 Bridge Street	Wairoa	
7-13 Bridge Street	Wairoa	
25 Shage Street	aran oa	
145 Carroll St	Wairoa	
145 Carroll St	Wairoa	
Carters National Office	Private Bag 94027	Manukau City
Carters National Office	Private Bag 94027	Manukau City
PO Box 54	Wairoa	
PO Box 54	Wairoa	
Juhaka Carago	22 Birinati Ct	DD 0
Nuhaka Garage	33 Riripeti St	RD 8
Nuhaka Garage	33 Riripeti St	RD 8
C/- Daniel Foster	1494 Nuhaka Ongutama Baad	RD 8
y- paniei Foster	1484 Nuhaka-Opoutama Road	KU 8
C/- Cindy Wills	19 Clifford Street	Gisborne
./- Ciriuy Wills	19 Cilliota Street	Gispottie

OccAddr1	OccAddr2	OccAddr3
PO BOX 460	Waikato Mail Centre	Hamilton
PO BOX 460	Waikato Mail Centre	Hamilton
PO BOX 460	Waikato Mail Centre	Hamilton
41 Valley Rd	RD 5	Wairoa
36 Valley Rd	RD 5	Wairoa
36 Valley Rd	RD 5	Wairoa
P O BOX 54	Wairoa	
3 Rotten Row	RD 5	Tuai
1 Rotten Row	RD 5	Wairoa
The Property Manager	PO Box 17188	Greenlane
PO Box 54	Wairoa	-
C/- R K Allott	PO Box 90	Frasertown
111 Clyde Rd	Wairoa	
PO Box 243	Wairoa	
PO Box 261	Gisborne	
7 Avon Tce	Taradale	Napier
7 Avon Tce	Taradale	Napier
C/- Wairoa Autobodies	36 Lucknow Street	Wairoa
PO Box 1048	Gisborne	vuii ou
1 0 BOX 10 10	- Cissonic	
C/- PGG Wrightson Ltd	Private Bag 1961	Dunedin
, 0	0	
18 Crarer Street	Wairoa	
528 Massey Road	Mangere	Auckland
528 Massey Road	Mangere	Auckland
528 Massey Road	Mangere	Auckland
PO Box 330	Wairoa	
PO Box 308	Wairoa	
PO Box 308 PO Box 742	Wairoa Gisborne	

OccAddr1	OccAddr2	OccAddr3
PO Box 490	Wairoa	
PO Box 490	Wairoa	
PO Box 54	Wairoa	
PO Box 86	Wairoa	
PO Box 34	Wairoa	
C/- Paul King	9 Lockwood Point	Wairoa
C/- Paul King	9 Lockwood Point	Wairoa
Private Bag 6203	Hawkes Bay Mail Centre	Napier
Private Bag 6203	Hawkes Bay Mail Centre	Napier
PO Box 41	Wairoa	
PO Box 41	Wairoa	
PU DUX 41	WallOd	

#### Notos

LOT 2 DP 4553 - 4 Stout Street, FrasertownSec 160 & 161 - 2 & 4 Bracken Street, Frasertown

Classification refers to a specific area under decommisioned shed on site, contaminated soil removed to landfill. Letter Genisis Energy 22.1.15

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Classification refers to a specific area under decommissioned shed on site, contaminated soil removed to landfill. Letter Genisis Energy 22.1.15

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Classification refers to a specific area under decommisioned shed on site, contaminated soil removed to landfill. Letter Genisis Energy 22.1.15

Locate report relating to "partly investigated" category

RHA for Clapham Sawmilling Limited, Carroll Street, Wairoa, relates to East Coast Lumber site, not this site. Timber treatment not carried out on this site, refer PDP report dated 10 May 2010,East Coast Lumber. Site ID 1408 is double up with Site 1419. RHA for Clapham Sawmilling Limited, Carroll Street, Wairoa, relates to East Coast Lumber site, not this site. Timber treatment not carried out on this site, refer PDP report dated 10 May 2010,East Coast Lumber. Site ID 1408 is double up with Site 1419. RHA for Clapham Sawmilling Limited, Carroll Street, Wairoa, relates to East Coast Lumber site, not this site. Timber treatment not carried out on this site, refer PDP report dated 10 May 2010,East Coast Lumber. Site ID 1408 is double up with Site 1419. RHA for Clapham Sawmilling Limited, Carroll Street, Wairoa, relates to East Coast Lumber site, not this site. Timber treatment not carried out on this site, refer PDP report dated 10 May 2010,East Coast Lumber. Site ID 1408 is double up with Site 1419. RHA for Clapham Sawmilling Limited, Carroll Street, Wairoa, relates to East Coast Lumber site, not this site. Timber treatment not carried out on this site, refer PDP report dated 10 May 2010,East Coast Lumber. Site ID 1408 is double up with Site 1419. RHA for Clapham Sawmilling Limited, Carroll Street, Wairoa, relates to East Coast Lumber site, not this site. Timber treatment not carried out on this site, refer PDP report dated 10 May 2010,East Coast Lumber. Site ID 1408 is double up with Site 1419. Double u

Double up with ID 1432. ID 1432 placed in "error" category

RHA - Carter Holt Harvey Building Supplies Ltd, MacDonald Street, Wairoa Consent No:DP 120337L. FK 19.11.15 CHH have site for sale

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Locate report/consent relating to "partially investigated" category

URS Soil Validation Assessment Oct 09 - UST removal ex Shell URS Soil Validation Assessment Oct 09 - UST removal ex Shell

#### CR Site Visit 6/10/2011

Double up with Site ID 1528 (Waihi, Wairoa) - ID 1528 in "error". Are some of these sites in private ownership now?

Double up with Site ID 1528 (Waihi, Wairoa) - ID 1528 in "error". Are some of these sites in private ownership now?

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Double up with Site ID 1528 (Walni, Walroa) - ID 1528 in "error". Are some of these sites in private ownership now?

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Double up with Site ID 1528 (Waihi, Wairoa) - ID 1528 in "error". Are some of these sets is in private ownership now?
Double up with Site ID 126 (Waini,Wairoa) - ID 128 in "error". Are some of these sites in private ownership now?
Double up with Site ID 1526 (Waini, Waino) - ID 1526 in "enror". Are some of these sites in private ownership now?
bouble up with site to 1520 (waith, waitua) - to 1520 in left of . Ale solite of these sites in private ownership now?
Owner, valuation etc updatedFuel tank originally washed out to sea
Owner, valuation etc updatedFuel tank originally washed out to sea
Current usage Residential & Joinery workshop, check historical site usage
Double up with ID 1447. ID 1447 placed in "error" category.HAIL A8
Double up with ID 1447. ID 1447 placed in "error" category.HAIL A8
Double up with ID 1447. ID 1447 placed in "error" category.HAIL A8
Double up with ID 1447. ID 1447 placed in "error" category.HAIL A8
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Double up with ID 1447. ID 1447 placed in "error" category.HAIL A8
Double up with ID 1447. ID 1447 placed in "error" category.HAIL A8
Double up with ID 1447. ID 1447 placed in "error" category.HAIL A8
Double up with ID 1447. ID 1447 placed in "error" category.HAIL A8
Double up with ID 1447. ID 1447 placed in "error" category.HAIL A8
Insufficient location details
Require legal description & valuation ID
Was this site previously a garage workshop-check with WDC
was this site previously a garage workshop-check with WDC  Was this step reviously a garage workshop-check with WDC
was tall site previously a garage workshop-theck with WDC
was tills site previously a garage workshop-theck with work
CDC: N. V. Challens Cl. J. Total V. Co.
CR Site Visit 67/102011. Check if 173 King St is correct address?
CR Site Visit 6/10/2011
Part of this site appears to be the Gasoline Alley Service Station. Is there a UST removal report for this site?
Part of this site appears to be the Gasoline Alley Service Station. Is there a UST removal report for this site?
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CR Site Visit dated 6/10/2011
CR Site Visit dated 6/10/2011 CR Site Visit dated 6/10/2011
UR Site Visit dated 6/10/2011  CR Site Visit dated 6/10/2011
CR Site Visit dated 6/10/2011
CR Site Visit dated 6/10/2011
Z Energy. Locate UST removal report & remediation of contaminated area
Legal, valuation and parcel updatedACTION: Resend letter
Google-Cookson Airspread, closed operations 1995. Possible UST still on site ex Cookson Air.PDP email (Z Energy) advising removal of 1 x UST 31800 L 24.9.12. ERM letter 10.03.15 soil validation report Z Energy.
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Google-Cookson Airspread, closed operations 1995. Possible UST still on site ex Cookson Airs Per entities (2 Energy) advising removal of 1 x UST 31800 L 24.9.12. ERM letter 10.03.15 soil validation report C Energy.

Google-Cookson Airspread, closed operations 1995. Possible UST still on site ex Cookson Air.PDP email (Z Energy) advising removal of 1 x UST 31800 L 24.9.12. ERM letter 10.03.15 soil validation report Z Energy.

Google-Cookson Airspread, closed operations 1995. Possible Ost Still on site ex Cookson Air.PDP email (2 Energy) advising removal of 1 x UST 31800 L 24.9.12. ERM letter 10.03.15 soil validation report Z Energy.

URS Letter 12/8/08Project no: 42766550UST removalBP Wairoa Truckstop was previous occupier of this site, dates in History are incorrect.

Diesel Contamination at the site of the Church of Latter Day Saints.MWH site report datedProject No 801/003592

Project Number: 48213.045Report 16/1/2002UPSS Decommissioning

PDP site investigation report dated 10 May 2010. HAIL A18

Boric Solution and PCP used on old sitePDP site investigation report dated 1 October 09

Boric Solution and PCP used on old sitePDP site investigation report dated 1 October 09

Tanker tipped and spilt onto a Paddock (owned by T. Hickling) on the 28th March 2007 just south of Nuhaka13900L Petrol450L of petrol and diesel mixURS report: 42759070

Consent No: DP950089L2.5haClosed in 1965180m North of the Beacons

Consent No: DP950090L2haClosed in 1965On a side road off the main road about 500m North of the Beacons

Above ground combined 1000L deisel & 500L petrol tankHerbicide storage

Above ground combined 1000L deisel & 500L petrol tankHerbicide storage

URS UST report dated 19 August 2010.Map Ref: NZTM 2010750E,5668420NLegal:Sec 10S,Omana Settlement

Joint HBRC/DOC premises - HBRC land - has DOC store with agrichemicals & fuel storage

Lake Waikaremoana Motorcamp (also known as Home Bay campground). Has refuelling facilities-DOC or Iwi owned?

DOC Field Centre Lake Waikaremoana - fuel storage

# **TANK REMOVAL CHECKLIST**

1. Name of business: Gair Contracting

2. Licence number: 1115

3. Location: 4 Putorino Station Road, Waikare

4. Property Number: 50178

5. Date of removal: 18 July 2002

6. Tank description: Tank 1: 4545l steel cylindrical

Tank 2: 4545l steel cylindrical

7. What was the contents of the tank(s)? T1 3(a) - Petrol T2 3C - diesel

8. What is the condition of the tank(s)? T1 good condition, no sign of deteriation

T2 Hole in bottom and severe stone pitting

bottom

9. Has all product been removed? Yes

10. Has there been any product leakage prior to removal? No

 Does the soil contain any hydro-carbon contamination? No, slight 'smell' around filling points but no real concern. Small quantity from hole on removal T2 but 2 cub m soil removed. Nil trace after this removal.

12. If yes, has the Environmental Resources Officer been notified? N/A

13. If the contamination is of a moderate to high level, contact Suzanne Porter at Regional Council. 835-3164. N/A

14. Soil sample taken by: (Consultant and Inspector) Colin Reid

15. Are all openings in the tank(s) and pipework securely closed and gas tight? DGR 55. Yes

16. Is the owner removing the tank? (Class 3 only) Yes

17. If no, do the removers have written authority from the licencing authority? DGR 56 N/A

18. What is the destination of the tank? Palmerston North - for destruction

19. If the tank is being disposed of to a new owner. Is it accompanied with a tank disposal notice and acceptance? N/A

20. Has GEMS been updated? YES / NO

21. Date updated. 30 July 2002

22. Have the dispensing pumps been removed? Yes

Inspector: Rick Sloman

Signature:

# **Additional Comments:**

No additional comments

# Photo List:


Tank 1



Tank 1 pit



Tank 2 in pit

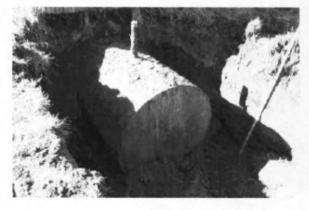


Tank 2



Tank 2 pit (with slight diesel residue on removal)



Tank 2 hole and pitting on base of tank

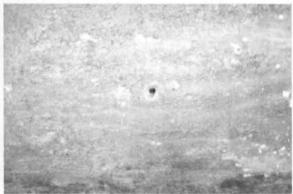

**Distribution:** 

Paul Hawke

Mark Boere

☐ Rick Sloman

☐ Malcolm Hart

□ Property File 4 Putorino Station Road, Waikare Property ID 50178

O Contamunated Site Database.



→ The Power of Commitment